

POINT BREEZE SCATTERED SITES REHABS

PHILADELPHIA REDEVELOPMENT AUTHORITY RENOVATIONS TO 1734 S. 24th STREET, PHILADELPHIA, PA

CODE INFORMATION

1. CITY OF PHILADELPHIA ZONING CODE:

- ZONING DISTRICT RSA-5
- BUILDING USE: SINGLE-FAMILY RESIDENCE
- MIN. LOT WIDTH: 16'-0"
- MIN. LOT AREA: 1440 SF
- MIN. % OPEN SPACE: 30% (INTERMEDIATE), 20% (CORNER)
- FRONT SETBACK: MATCH EX'G. ADJACENT BUILDINGS, 3RD STORY SETBACK MUST BE 8'-0" FROM PROPERTY LINE IF BOTH IMMEDIATELY ADJACENT STRUCTURES ARE TWO STORIES IN HEIGHT.
- REAR YARD: THE GREATER OF 9FT OR 20% OF LOT DEPTH
- HEIGHT: 38 FT

2. INTERNATIONAL BUILDING CODE + INTERNATIONAL RESIDENTIAL CODE, 2009:

- USE GROUP: RESIDENTIAL R3
- CONSTRUCTION TYPE: VB
- FIRE DISTRICT: CITY OF PHILADELPHIA
- CONSTRUCTION TYPE PERMITTED WITHIN FIRE DISTRICT: YES
- BUILDING HEIGHT & FIRE AREA LIMITATIONS

CONSTRUCTION USE GROUP	ALLOWABLE CLASSIFICATION	ALLOWABLE AREA S.F.	ALLOWABLE HEIGHT
R3	TYPE VB	UNLIMITED	3 STORIES

- BASEMENTS, HABITABLE SLEEPING ATTIC & SLEEPING ROOMS EMERGENCY EGRESS WINDOW SIZE REQUIREMENTS:

- MIN. NET CLEAR OPENING = 5.7 SF (5.0 SF ON GRADE FLOOR)
- MIN. NET CLEAR OPENING HEIGHT = 24 INCHES
- MIN. NET CLEAR OPENING WIDTH = 20 INCHES
- MAX. SILL HEIGHT = 44 INCHES
- STAIR REQUIREMENTS:
 - MAX. RISER = 8 1/4 INCHES, MIN. TREAD 9 INCHES, MIN. WIDTH = 36 MAX. RISER VARIATION 3/8 INCH
 - MIN. CLEAR HEADROOM = 6'-8" APPROX. 3/4" NOSING PROJECTION FOR CLOSED RISERS.
- HANDRAILS - REQUIRED ON ONE SIDE ONLY
 - MIN. HEIGHT = MEASURED ABOVE NOSING: 34 INCHES, MAX. HEIGHT = 38 INCHES.
- GUARDRAILS - REQUIRED FOR STAIRS, PORCHES, BALCONIES, OR RAISED FLOORS MORE THAN 30" ABOVE THE FLOOR OR GRADE BELOW.
 - MIN. HEIGHT = 36 INCHES MIN. AT BALCONIES AND FLOORS, 34" INCHES MIN. ABOVE NOSING OF STAIRS.
 - MAX. OPENING BETWEEN INTERMEDIATE RAILS 4 INCHES
- SMOKE AND CARBON MONOXIDE DETECTORS SHALL BE INSTALLED IN IMMEDIATE VICINITY OF BEDROOM/SLEEPING AREAS, IN ALL BEDROOMS, WITHIN EACH STORY INCLUDING THE BASEMENT.

3. BUILDING AREAS:

	GSF	NSF	# BEDROOMS	# BATHROOMS
BASEMENT:				
FIRST FL:	(603 S.F.)	404 S.F.	3	1/2
SECOND FL:	508 S.F.	508 S.F.		1
TOTAL:	1727 S.F.	912 S.F.	3	1 1/2

LOCATION MAP (NTS)



SYMBOL KEY

+ 461.0	EXISTING SPOT ELEVATION	100-A	DOOR/OPENING NUMBER
TB-2	TEST BORING	2'8"	NEW DOOR/DOOR SIZE
HIGH POINT OF ROOF EL. 20'-0"	LEVEL LINE	A1	REVISION NUMBER
2	COLUMN CENTER LINE	EXISTING CONSTRUCTION	EXISTING CONSTRUCTION
F1 A1.1	INTERIOR ELEVATIONS	NEW CONSTRUCTION	NEW CONSTRUCTION
F1 A1.1	WALL SECTION	CENTER LINE, FLOOR LINE	CENTER LINE, FLOOR LINE
F1 A1.1	BUILDING SECTION	PROPERTY LINE	PROPERTY LINE
I A1.1	DETAIL REFERENCE	OVERHEAD CONDITIONS	OVERHEAD CONDITIONS
F1 A1.1	ELEVATION	ITEMS TO BE DEMOLISHED	ITEMS TO BE DEMOLISHED
BEDROOM ROOM NAME CPT FLOOR FINISH		BREAK LINE	BREAK LINE
DOORS & WINDOWS		DIMENSION TO CENTER LINE	DIMENSION TO CENTER LINE
EXISTING DOOR		5'	DIMENSION LINE
PARTITION TYPE SEE SHEET A2.0		1	EQUIPMENT NUMBER
WINDOW TYPE		30°	ANGLE
ROOF VENT		R	PLATE
		C	CENTER LINE
		R3/4	RADIUS POINT
		I	SPECIAL NOTE
		H	HOSE BIB

ABBREVIATIONS

AB ANCHOR BOLT	EA EACH	LAM LAMINATED	SCHED SCHEDULE
ABV ABOVE	EJ EXPANSION JOINT	LT LIGHT	SC SOLID CORE
ACT ACOUSTIC CEILING TILE	ELEC ELECTRIC(AL)	LVR LOUVER	SF SQUARE FEET
ADJ ADJACENT	EL ELEVATION	MANUF MANUFACTURE(R)	SHT SHEET
AFF ABOVE FINISHED FLOOR	ELEV ELEVATOR/ELEVATION	MAT MATERIAL	SIM SIMILAR
ALUM ALUMINUM	EQ EQUAL	MECH MECHANICAL	SL SEALANT
ACP ACOUSTIC CEILING PANELS	EST ESTIMATED	MTL METAL	SL & BR SEALANT & BACKER ROD
ARCH ARCHITECT(URAL)	ETR EXISTING TO REMAIN	MO MASONRY OPENING	SLF SHEET LINOLEUM FLOORING
@ AT	EVC EXHAUST COOLER	MR MOISTURE RESISTANT	SP SUMP PUMP
BACKSPL BACKSPLASH	EXG EXISTING	MRBL MARBLE	SPECS SPECIFICATIONS
BD BOARD	EXIST EXISTING	MSNRY MASONRY	STC SOUND TRANSMISSION CLASS
BTWN BETWEEN	EXH EXHAUST	MTD MOUNTED	STD STANDARD
BLK BLOCK	EXT EXTERIOR	NEC NECESSARY	STL STEEL
BLKG BLOCKING	FD FLOOR DRAIN	NIC NOT IN CONTRACT	STN STONE
BO BOTTOM OF	FE FIRE EXTINGUISHER	NO NUMBER	SSTL STAINLESS STEEL
BOC BOTTOM OF CURB	FEC FIRE EXTINGUISHER CABINET	NRC NOISE REDUCTION COEFFICIENT	STRUC STRUCTURE(AL)
BOT BOTTOM	FIN FINISH(ED)	NTS NOT TO SCALE	SUSP SUSPEND(ED)
BRK BRICK	FLD FIELD	OC ON CENTER	SVF SHEET VINYL FLOORING
BSMT BASEMENT	FLSG FLASHING	OD OUTSIDE DIAMETER	T TREAD
BUR BUILT UP ROOFING	FLR FLOOR	OPPHD OPPOSITE HAND	TA TOILET ACCESSORY
CAB CABINET	FO FACE OF	OPNG OPENING	TEMP TEMPORARY
CB CATCH BASIN	FR FRAME	ORIG ORIGINAL	THK THICK/THICKNESS
CEM CEMENT	FRT FLAME RETARDANT TREATED	PERF PERFORATED	THRES THRESHOLD
CER CERAMIC	FRTG FIRE RATING	PL PLATE	TO TOP OF
CJ CONTROL JOINT	FUR FURRING	PLAM PLASTIC LAMINATE	TOC TOP OF CURB
CL CENTER LINE	GA GAUGE	PLSTR PLASTER	TYP TYPICAL
CLG CEILING	GALV GALVANIZED	PLYWD PLYWOOD	UL UNDERWRITERS LABORATORIES
CMU CONCRETE MASONRY UNIT	GC GENERAL CONTRACTOR	PNL PANEL	UNO UNLESS NOTED OTHERWISE
COL COLUMN	GL GLASS	PR PAIR	VB VAPOR BARRIER
COMP COMPOSITE/COMPOSITION	GWB GYPSUM WALL BOARD	PT PRESSURE TREATED	VCB VINYL COVE BASE
CONC CONCRETE	GYP GYPSUM	PTD PAINTED	VCT VINYL COMPOSITE TILE
CONT CONTINUOUS	HC HOLLOW CORE	QT QUARRY TILE	VERT VERTICAL
CONTR CONTRACT(OR)	HDW HARDWARE	R RADIUS/RISE	VIF VERIFY IN FIELD
CORR CORRIDOR	HM HOLLOW METAL	RCB RUBBER COVE BASE	W/ WITH
CPT CARPET	HOR HORIZONTAL	RD ROOF DRAIN	W/O WITHOUT
CS COURSE	HT HEIGHT	RECP RECEPTACLE	WD WOOD
CTR COUNTER	HDWD HARDWOOD	REFRB REFURBISH	WDW WINDOW
CT CERAMIC	ID INSIDE DIAMETER	REIN REINFORCED/REINFORCING	WVP WATERPROOFING
DTL DETAIL	INSUL INSULATION	RELOC RELOCATE	WRB WATER RESISTIVE BARRIER
DIA DIAMETER	INT INTERIOR	REM REMOVE(D)	WSC WAINSCOT
DIM DIMENSION	JT JOINT	REQD REQUIRED	WWF WELDED WIRE FABRIC
DN DOWN	JST JOIST	RF MEM ROOFING MEMBRANE	
DS DOWNSPOUT		RO ROUGH OPENING	
DR DOOR		RWC RAINWATER CONDUCTOR	
DWG DRAWING			

DRAWING LIST

CS COVER SHEET
A1.1 FLOOR PLANS, DEMO PLANS & FRAMING PLANS
A1.2 REFLECTED CEILING PLANS
A2.1 INTERIOR AND EXTERIOR ELEVATIONS
A4.1 STAIR AND WALL SECTIONS & DETAILS
A6.1 SCHEDULES AND DETAILS
A6.2 SCHEDULES AND DETAILS


GENERAL NOTES

- REMOVE ALL DEBRIS AND VEGETATION FROM SITE. DEMOLISH ALL EXISTING REAR YARD PAVING + CURBS, COMPLETE. DEMOLISH GARDEN/SITE WALLS UNLESS INDICATED TO REMAIN ON PLANS. COORDINATE WITH NEIGHBORING PROPERTIES AS REQUIRED. INSTALL NEW 4" CONC. PAVING WITH LANDSCAPING BEDS AS INDICATED ON PLANS. SLOPE CONC. PAVING TO NEW AREA DRAIN.
- DEMO EXISTING ROOF SYSTEM, COMPLETE. INSTALL NEW LOW-SLOPE MODIFIED BITUMEN ROOF WITH GRANULAR WHITE COATING. FURNISH AND INSTALL NEW ALUM. COPING, SCUPPER AND DOWNSPOUTS, TYP.
- DEMO ALL INTERIOR WALLS, FINISHES & TRIM, HVAC, PLUMBING & ELECTRICAL SYSTEMS. DEMO ALL EXISTING WINDOWS AND INSTALL NEW WINDOWS IN EX'G OPENINGS. INSTALL NEW EXTERIOR DOORS, WITH STORM DOORS AT ALL REAR DOORS AND SECURITY STORM DOOR WHERE INDICATED AT FRONT DOORS.
- DEMO ALL EXISTING NON-FUNCTIONING CHIMNEYS, COMPLETE.
- NEW INTERIOR PARTITIONS ARE TO BE WALL TYPE (B) U.O.N. PROVIDE NEW INTERIOR STANDING AND RUNNING TRIM AND DOORS.
- INSTALL CLOSET ROD & SHELF AT ALL CLOSETS EXCEPT AT LINEN CLOSETS. INSTALL NEW VENTILATED WHITE WIRE SHELVING AT ALL LINEN CLOSETS, (5) SHELVES PER LINEN CLOSET.
- ALL STAIRS SHALL HAVE 9" TREADS WITH 1" OVERHANG, 8 1/4" MAX. RISERS, & 80" HEAD CLEARANCES FROM FRONT OF TREAD TO BOTTOM OF CEILING.
- AIR SEAL ALL DRYWALL ASSEMBLIES. INSTALL CONTINUOUS SEALANT ALONG: (1) ALL EXTERIOR WALL BOTTOM AND TOP PLATES, (2) ALL TOP PLATES AT INSULATED CEILINGS, (3) ROUGH OPENING PERIMETERS, (4) BOTH SIDES OF THE FIRST INTERIOR STUD OF PARTITION WALLS, (5) ALL RECESSED LIGHT FIXTURES IN INSULATED CEILINGS, AND (6) ALL ELECTRIC BOX PENETRATIONS.
- DEMO ALL EXISTING FENCES. COORDINATE W/ NEIGHBORING PROPERTIES. INSTALL NEW 6'-0" WOOD SHADOWBOX STYLE PERIMETER FENCE W/ 3'-0" SWINGING GATE AT ALL REAR YARDS.
- CLEAN AND REPOINT ALL BRICK FRONT FACADES.
- DEMO EXISTING SLABS IN BASEMENTS AND EXCAVATE FOR NEW SLAB AND DRAINAGE FILL. DO NOT EXCAVATE BELOW THE LEVEL OF THE BOTTOM OF THE EXISTING BASEMENT FOUNDATION WALLS. INSTALL NEW 4" CONC SLAB ON 4" DRAINAGE FILL & VAPOR BARRIER WITH PERIMETER PERFORATED DRAIN PIPE SLOPED TO DRAIN TO NEW SUMP PIT.
- PARGE INTERIOR FACE OF ALL EXISTING BASEMENT WALLS.
- PARGE INTERIOR FACE OF ALL EXISTING MASONRY WALLS AT FIRST FLOOR AND SECOND FLOOR INCLUDING PARTY WALL.
- CONTRACTOR TO CONTACT PENNSYLVANIAN ONE CALL SYSTEM, 1-800-242-1776, FOR LOCATION OF ALL SITE UTILITIES IN SIDEWALK AND STREET PRIOR TO THE START OF ANY EXCAVATION.

ALL DIMENSIONS AND EXISTING CONDITIONS SHALL BE AS SHOWN ON THE CONTRACT DOCUMENTS. THE CONTRACTOR SHALL VERIFY THE WORK SHALL COMPLY WITH APPLICABLE CODES AND REGULATIONS. JURISDICTION: PHILADELPHIA, PA. © 2014 CICADA ARCHITECTURE/PLANNING, INC.

REVISIONS	DESCRIPTION	BY	DATE
No.			

CONSULTANTS:

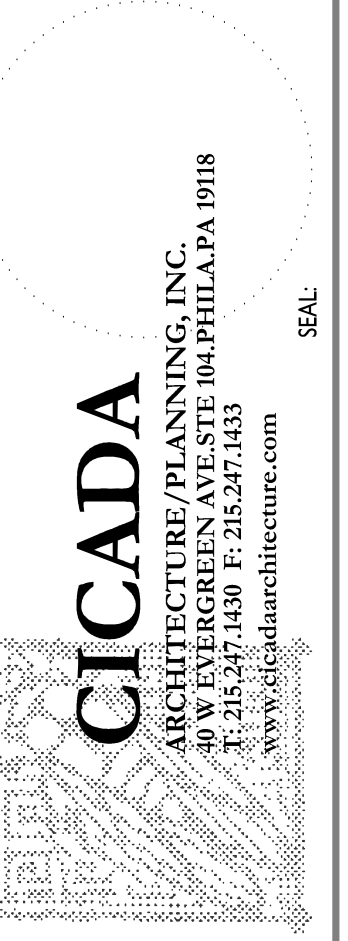

PROJECT: POINT BREEZE SCATTERED SITES REHABS PHILADELPHIA REDEVELOPMENT AUTHORITY PHILADELPHIA, PA

SHEET TITLE: COVER SHEET 1734 S. 24th ST. PROJECT NO.: 419.00

SCALE	AS NOTED
DRAWN BY:	TS
APPROVED:	MB
DATE:	07/28/2014
DRAWING NO.:	

CS

LIGHTING/POWER SYMBOLS:


<ul style="list-style-type: none"> ☐ TELEPHONE/DATA 📺 TV CABLE ⊖ RECESSED FIXTURE ⊕ WALL-MTD FIXTURE ⊖ PENDANT FIXTURE ⊕ JUNCTION BOX ⊕ HOSE BIB 	<ul style="list-style-type: none"> Ⓢ SWITCH ⊖ EXHAUST FAN ⊖ ELECTRIC OUTLET Ⓢ SMOKE DETECTOR Ⓢ SMOKE DETECTOR AND CARBON MONOXIDE DETECTOR ⊖ CEILING-MTD FIXTURE ⊕ CEILING FAN w/ Light 	<ul style="list-style-type: none"> Ⓛ ELEC PANEL 🔔 DOOR BELL ☐ 2X4 SURFACE FLUORESCENT — UNDERCABINET LIGHT SIZE TO SUIT CONDITIONS
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KEY NOTES

- 01 CLOSET ROD AND SHELF.
- 02 NEW CONCRETE PAVING WITH CONTROL JOINTS AS SHOWN.
- 03 NEW EXTERIOR STAIR AND LANDING WITH HANDRAIL SEE DET. E4/A4.1
- 04 NEW GUTTER/SCUPPER, DOWNSPOUT, CAST IRON BOOT AND AREA DRAIN. PROVIDE NEW STORMWATER LINE AND CLEANOUT IN BASEMENT.
- 05 NEW 6'-0" WOOD SHADOWBOX TYPE FENCE AND 3'-0" W GATE W/ LOCKING HARDWARE.
- 06 NEW HOSE BIBB.
- 07 NEW 4" CONCRETE SLAB; SLOPE TO SUMP PUMP. EXCAVATE TO ACHIEVE MIN. 7'-4" CLG HT IN BASEMENT. INSTALL NEW 4" PERF. DRAINAGE PIPE AROUND SLAB PERIMETER + CONNECT TO SUMP PUMP.
- 08 SEED + SOD PLANTING BED.
- 09 PROVIDE WASHER/DRYER HOOK-UPS BOXL.
- 10 NEW EXTERIOR STAIR AND LANDING.
- 11 NEW BLOCK VENT.


DRAWING KEY

▨	NEW PARTITION
—	NEW WORK
- - -	EX'G. TO REMAIN
- · - · -	EX'G. TO BE DEMOLISHED
▢	2 HR FIRE RATED CONSTR.
⊖	SUPPLY GRILLE
⊕	RETURN GRILLE
⊖	SUPPLY DUCT
⊕	RETURN DUCT
↔	WALL RETURN

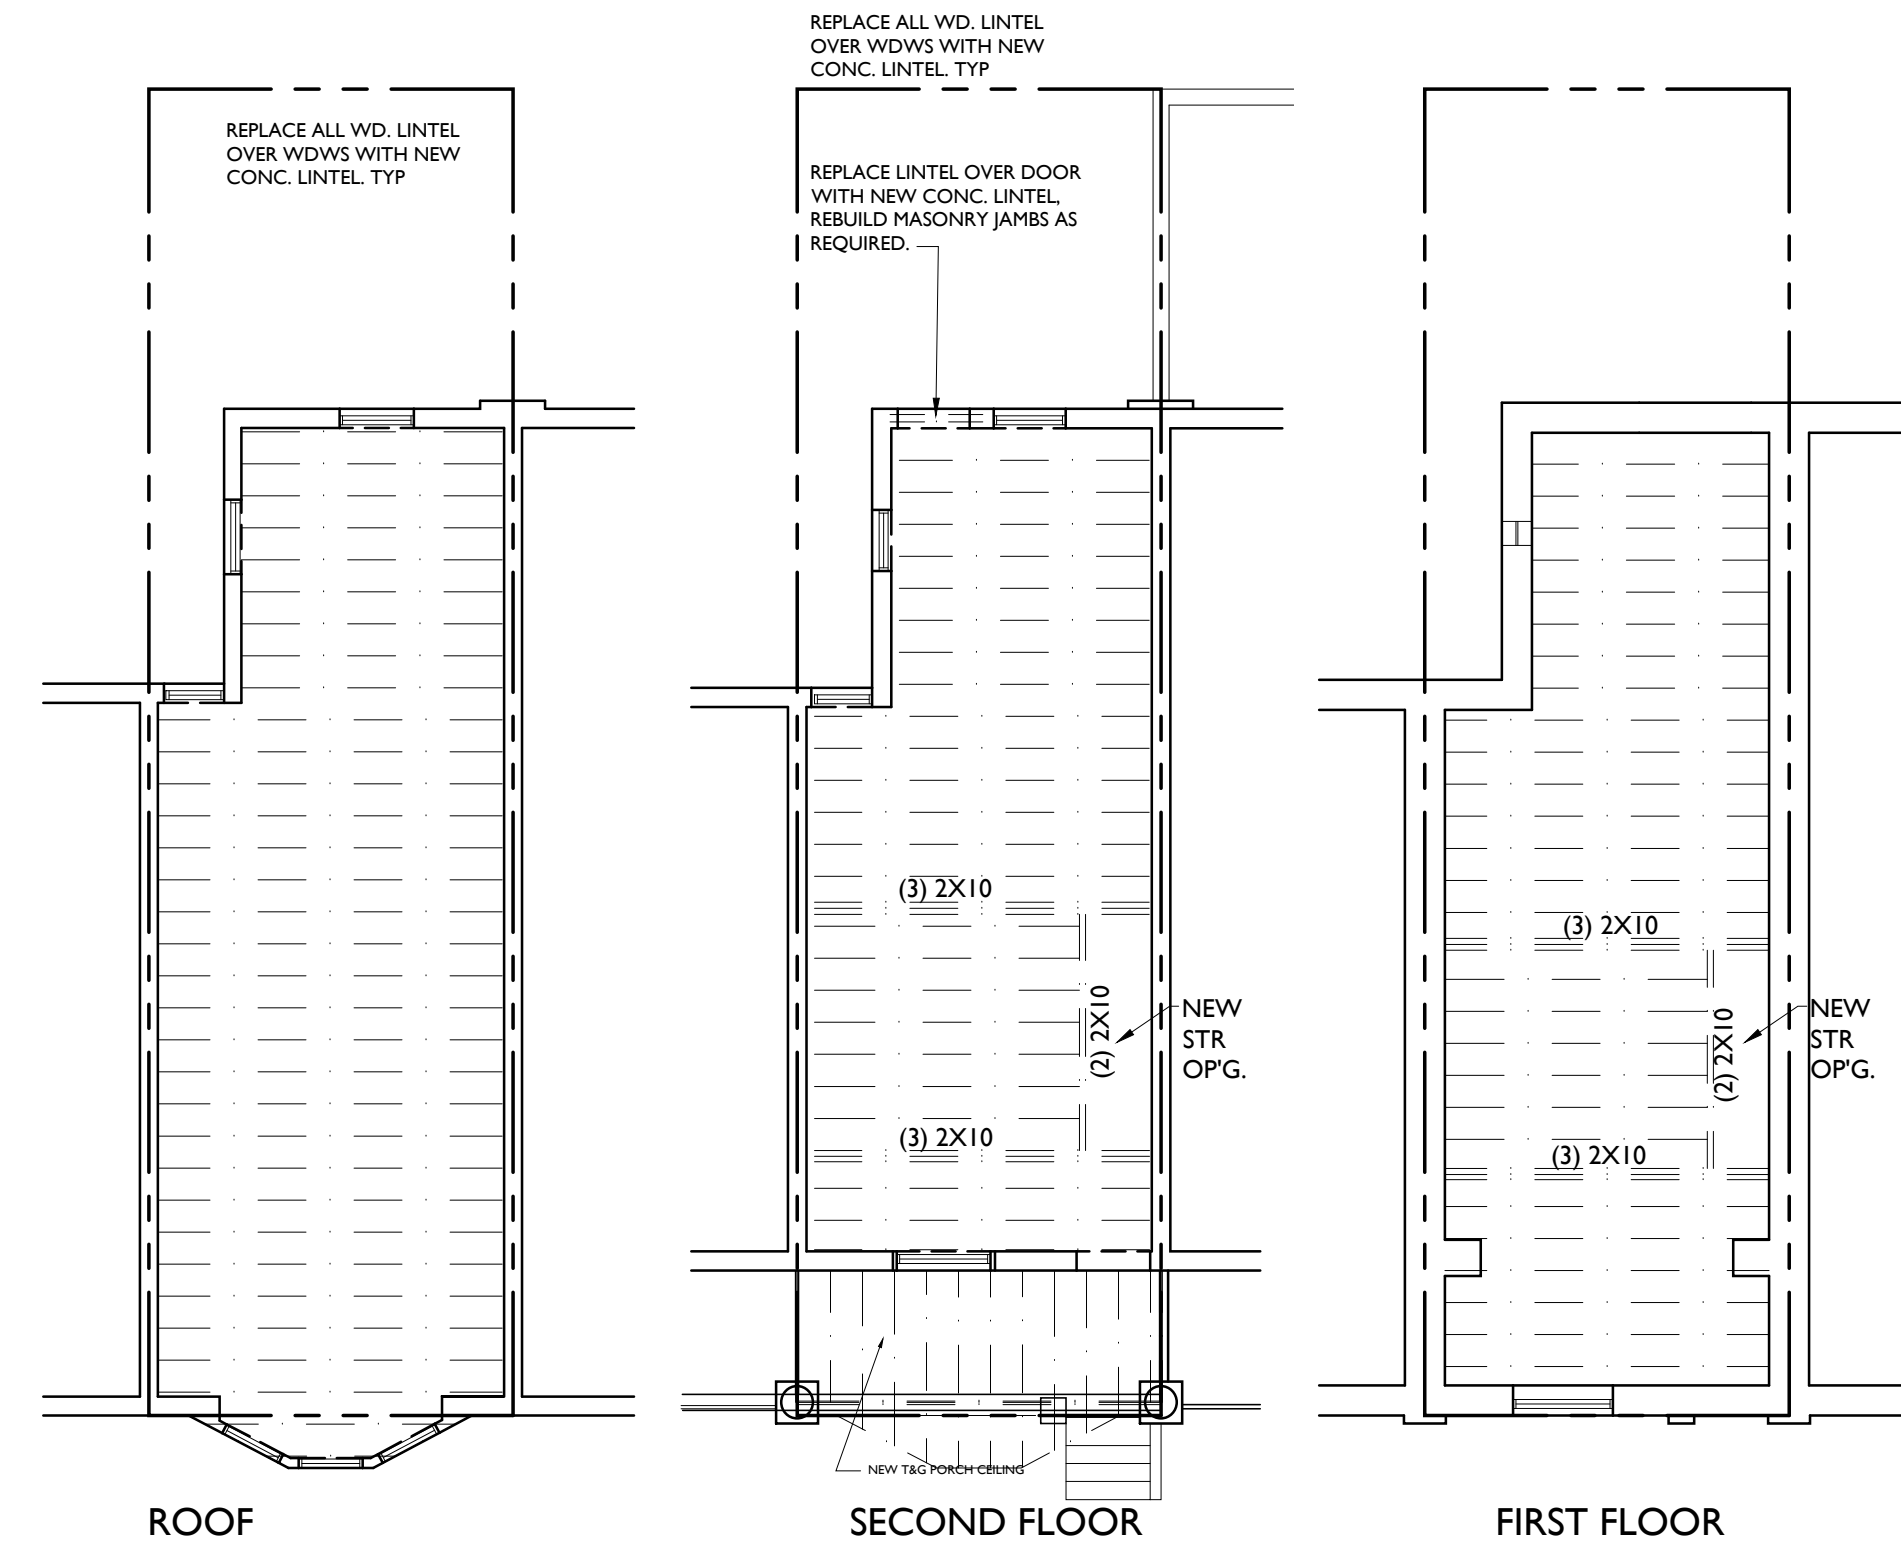


C1 STRUCTURAL FRAMING PLANS
1/8" = 1'-0"


DEMO - FRAMING NOTE
1. DEMO TO STRUCTURE. DEMO ALL FLOOR JOISTS AND ROOF RAFTERS, COMPLETE. PROVIDE ALL NEW 2X10'S AT 16" O.C. FOR FLOOR AND ROOF FRAMING MEMBERS. FRAME FOR NEW STAIR, SEE SECTION B4/A4.1 AND DETAILS E2 & E3/A4.1.

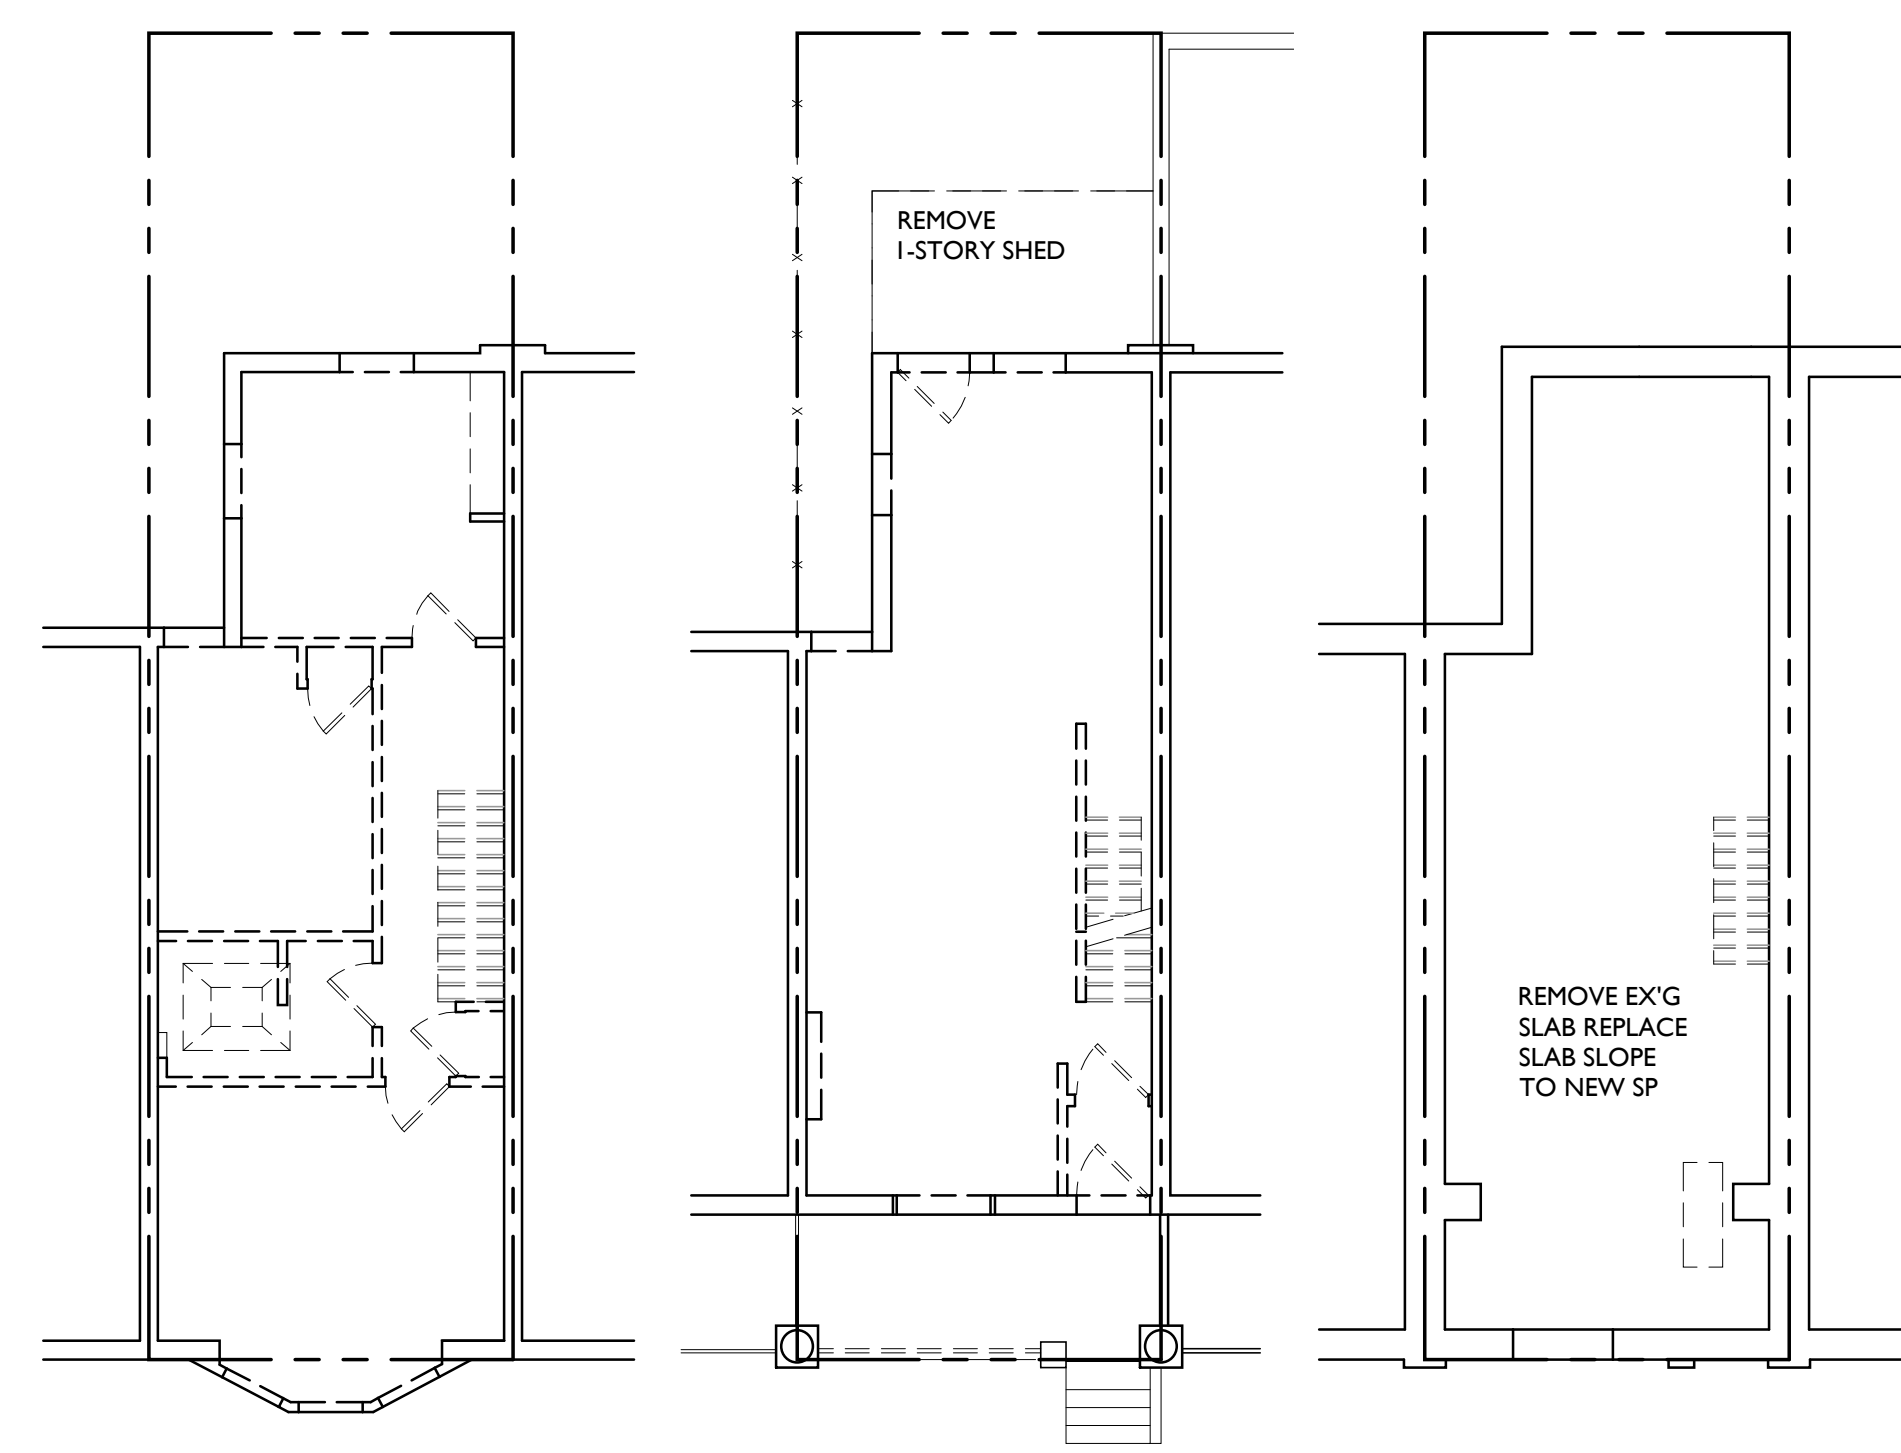


E1 DEMOLITION PLANS
1/8" = 1'-0"

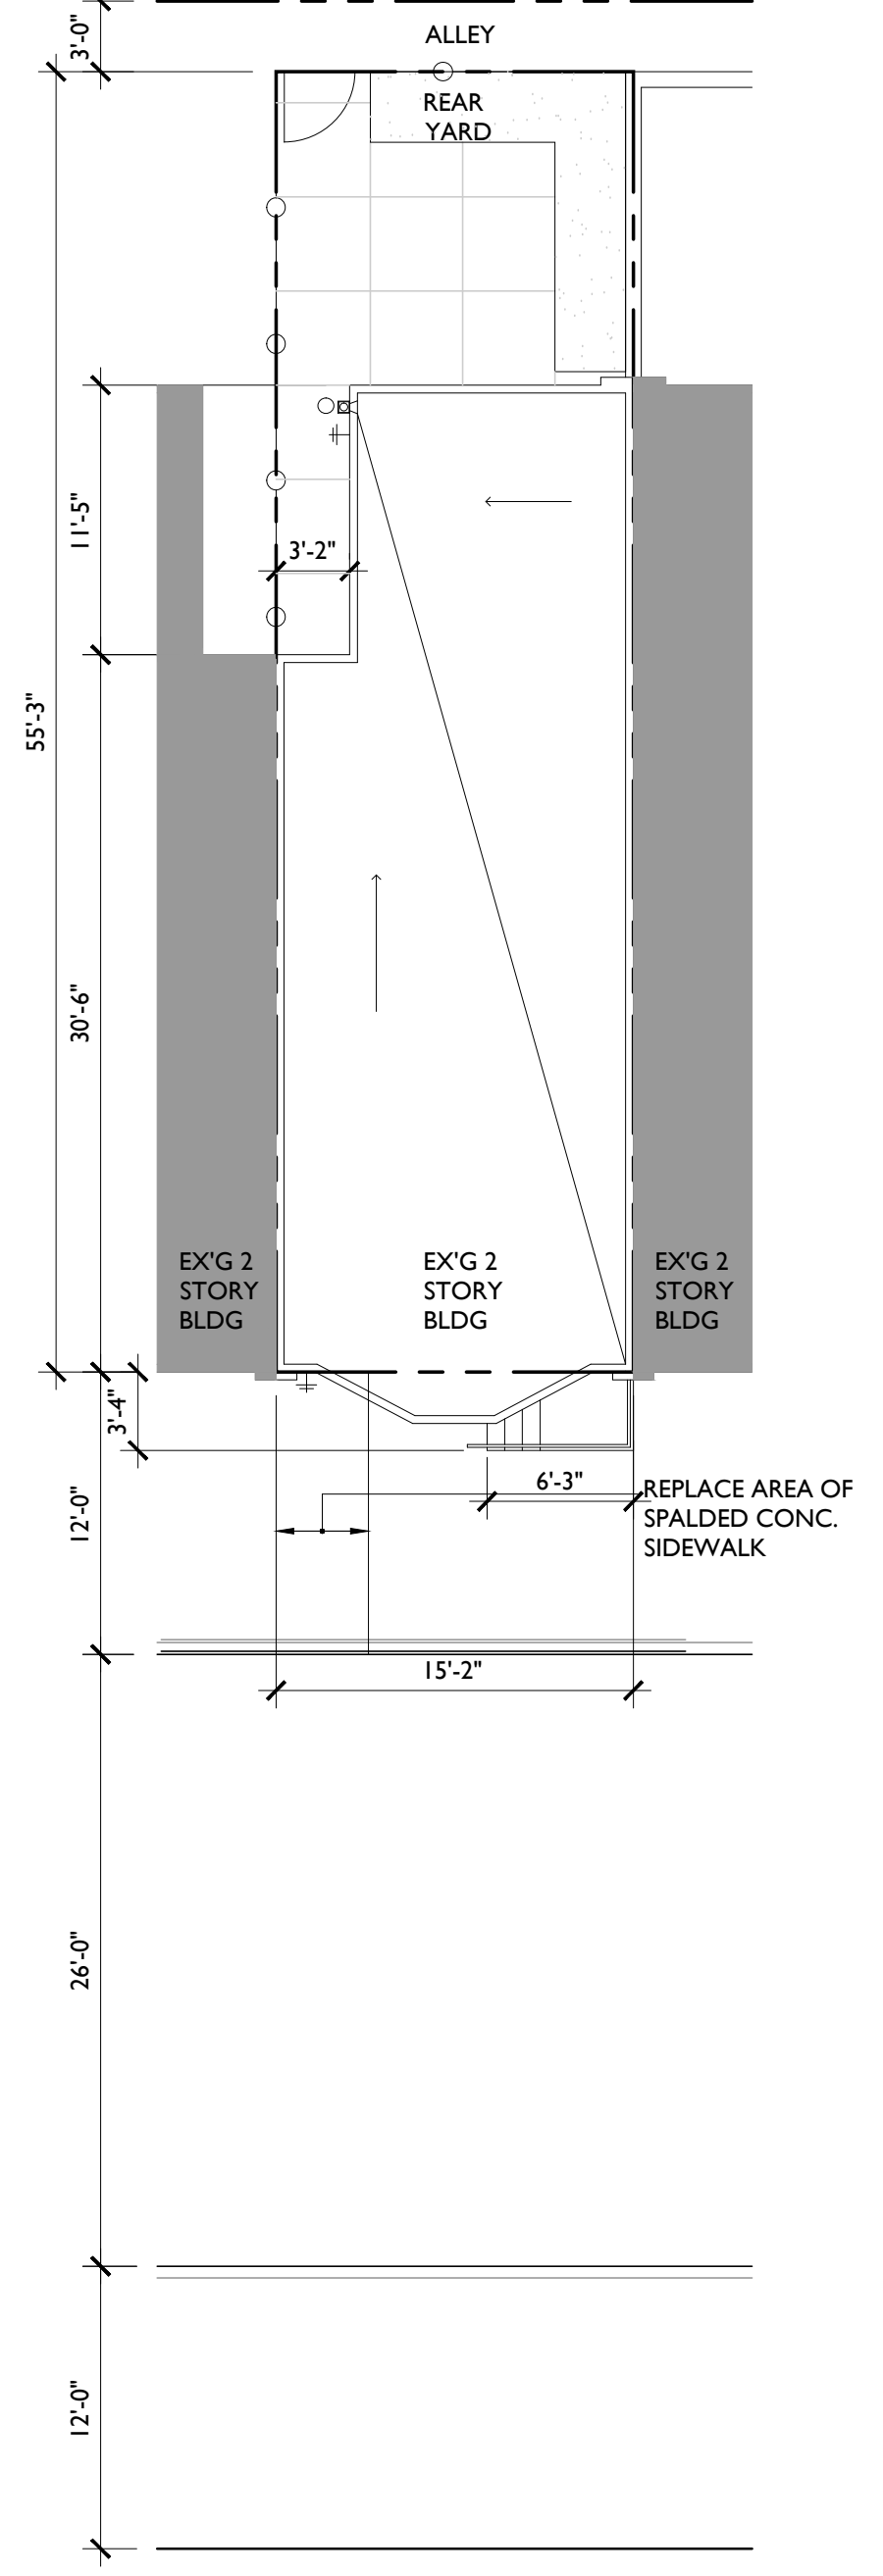


E3 ROOF/SITE PLAN
1/8" = 1'-0"

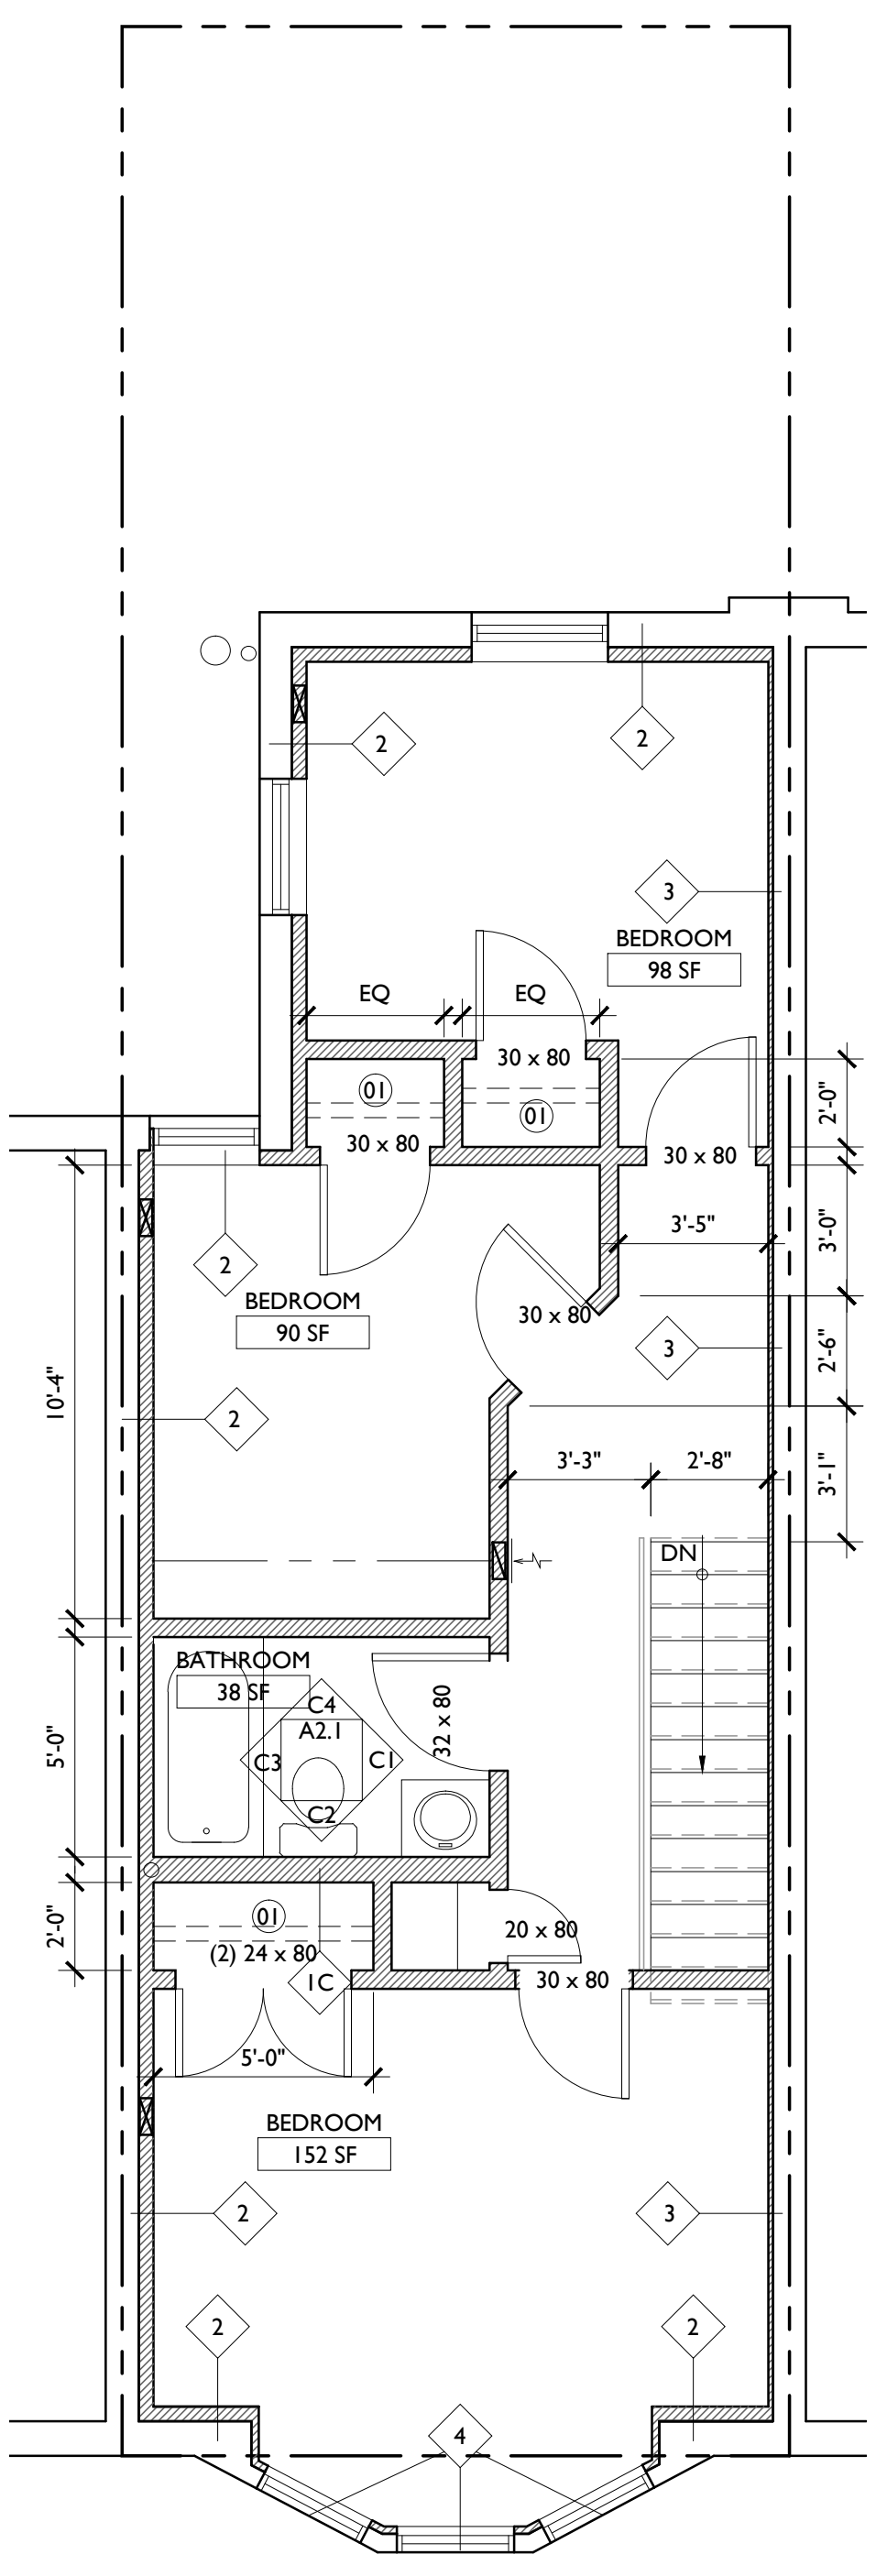

E4 SECOND FLOOR PLAN
1/4" = 1'-0"

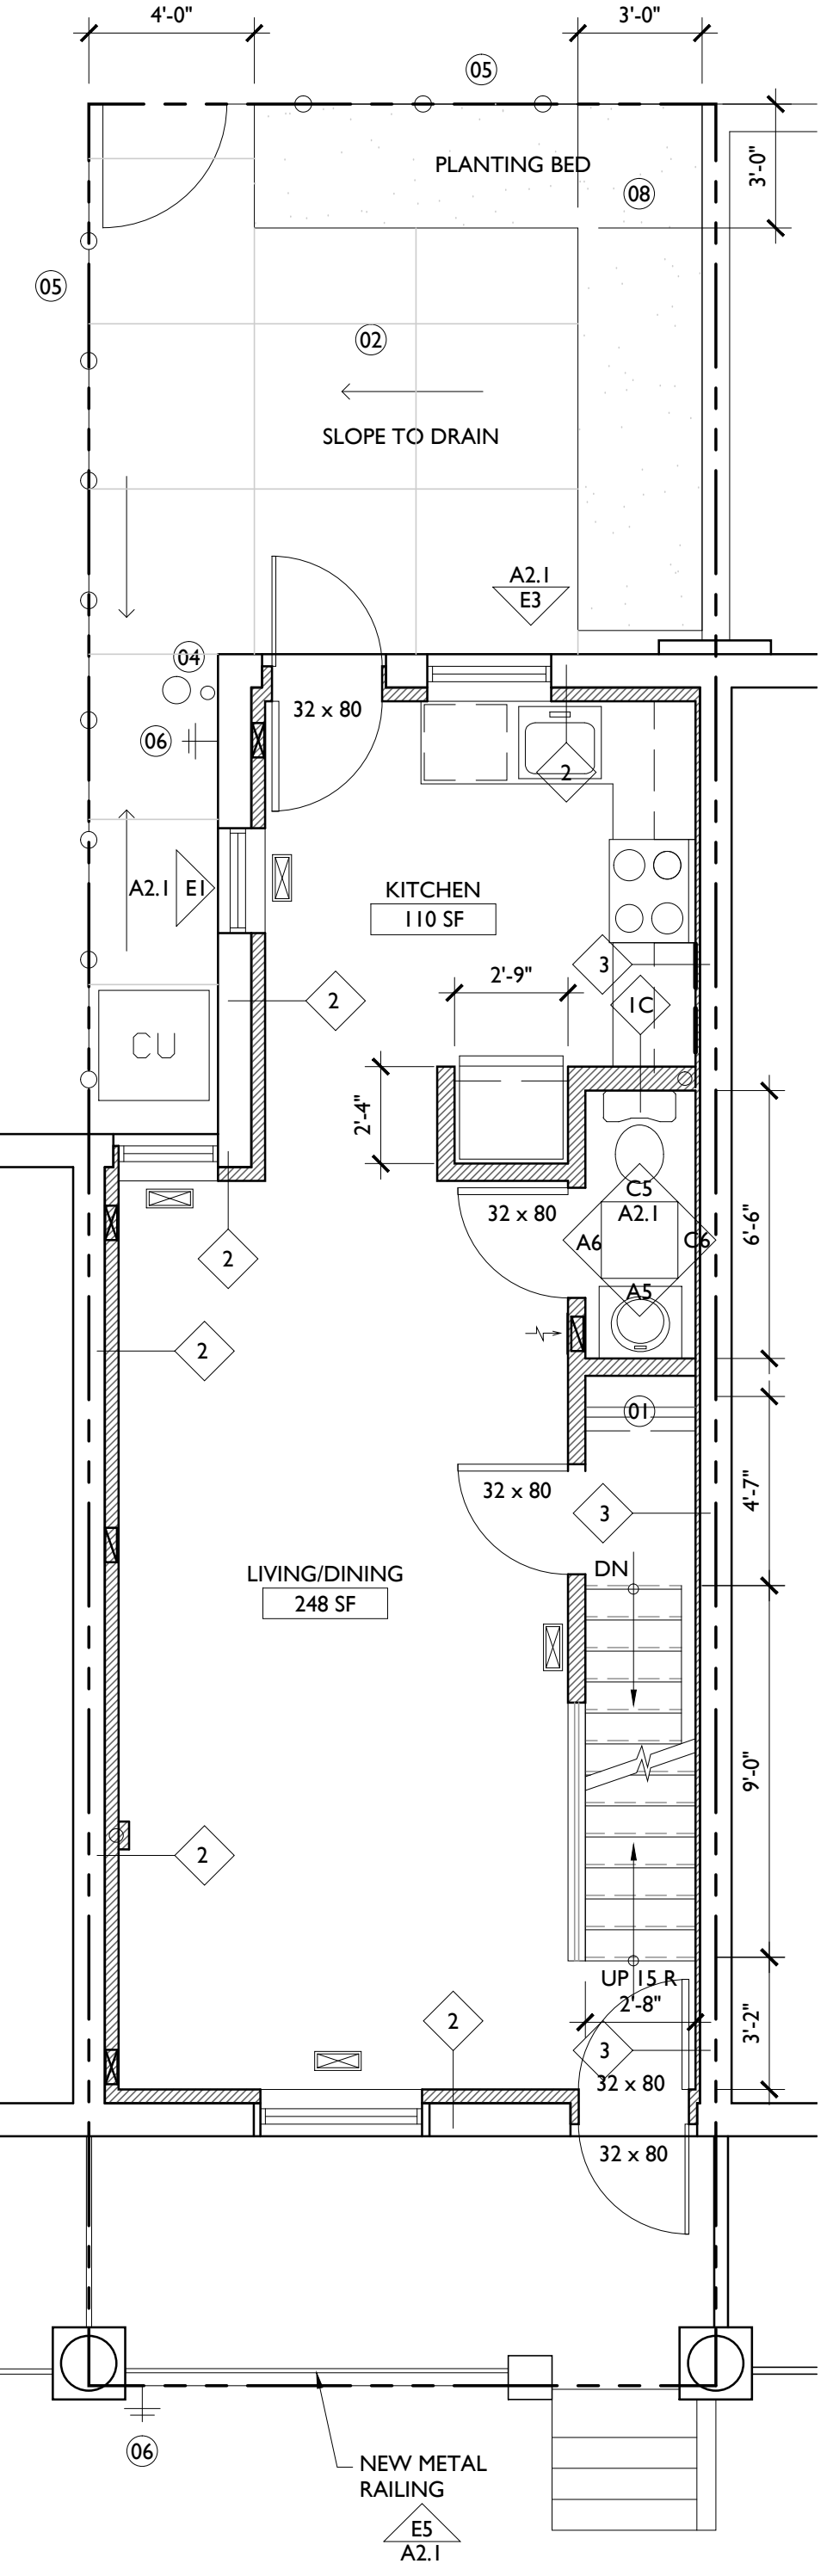

E5 FIRST FLOOR PLAN
1/4" = 1'-0"

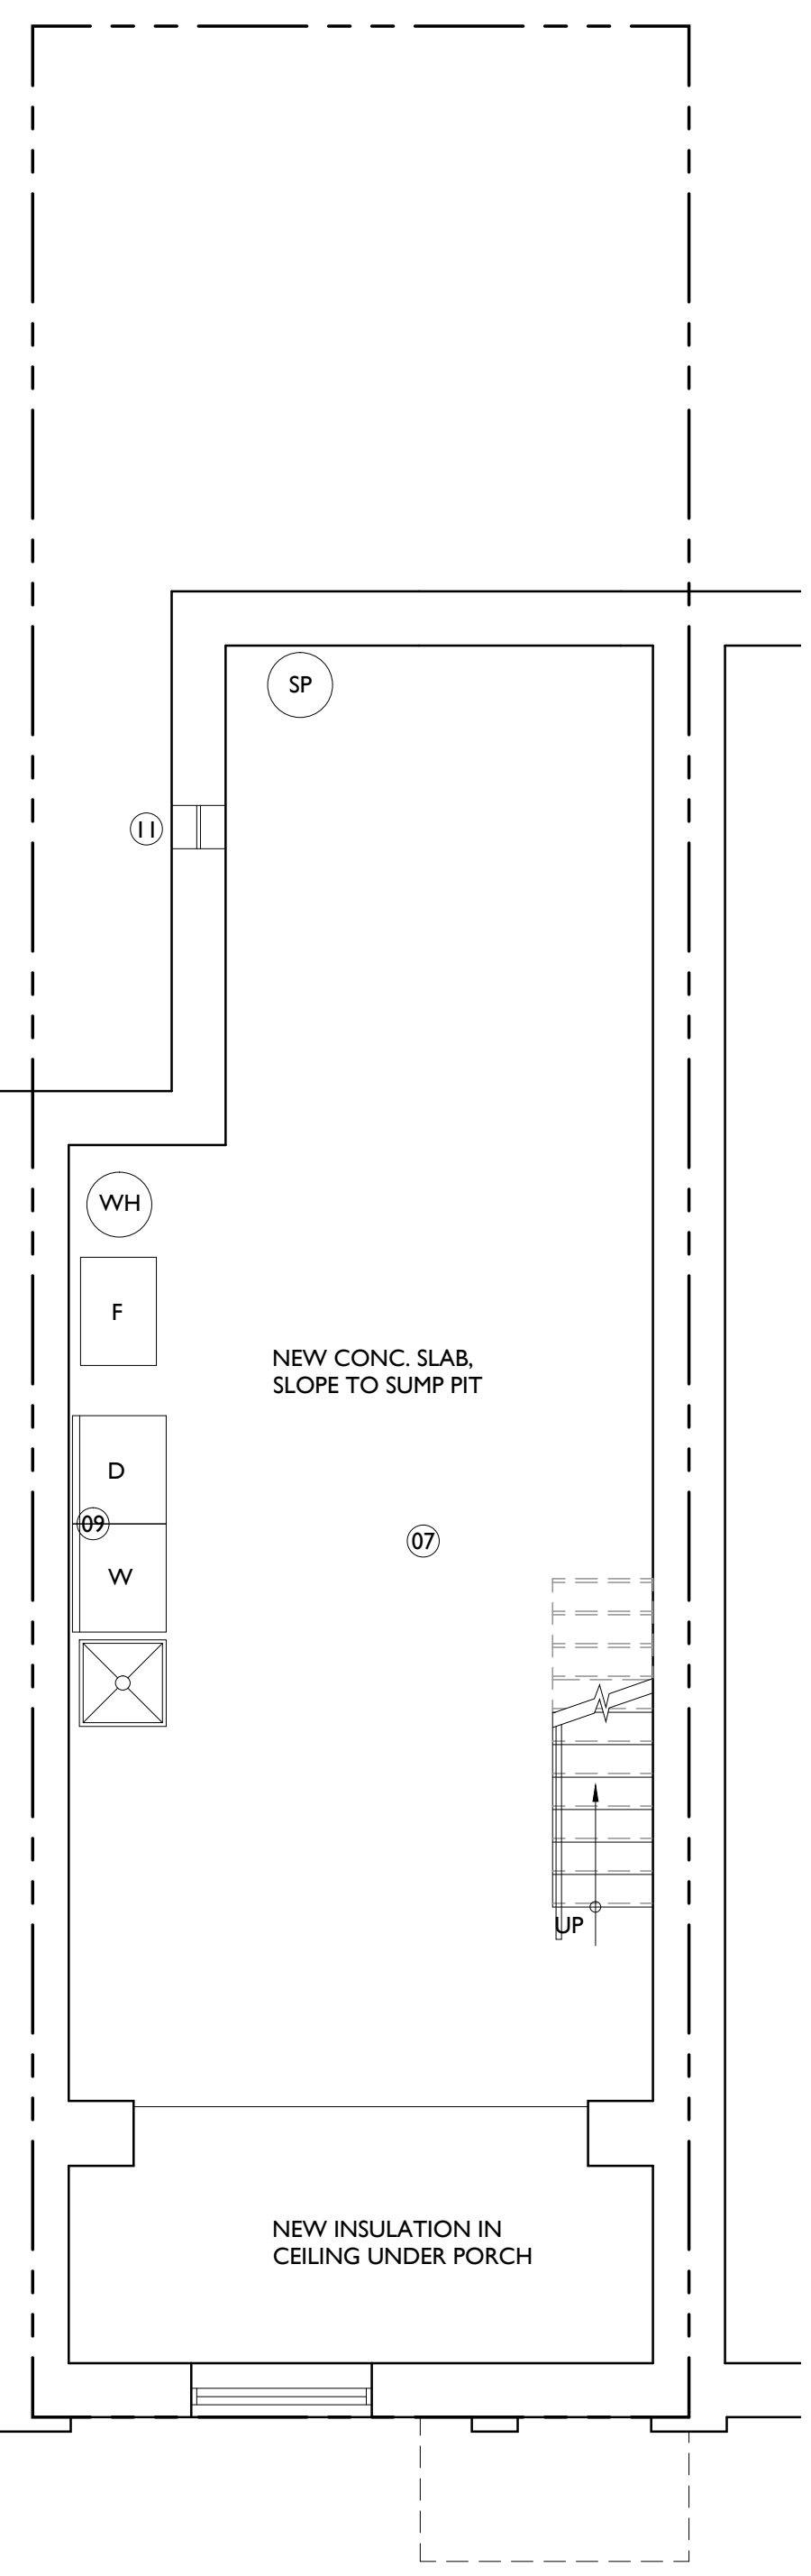

E6 BASEMENT FLOOR PLAN
1/4" = 1'-0"

ALL DIMENSIONS AND EXISTING CONDITIONS SHALL BE AS SHOWN ON THE CONTRACT DOCUMENTS AT THE SITE. THE WORK SHALL COMPLY WITH APPLICABLE CODES AND REGULATIONS. THE CONTRACTOR SHALL OBTAIN ALL NECESSARY PERMITS FROM THE APPROPRIATE JURISDICTION.
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REVISIONS:

No.	DATE	DESCRIPTION

CONSULTANTS:

BY: _____
DATE: _____

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PROJECT: **POINT BREEZE SCATTERED SITE REHABS**
PHILADELPHIA REDEVELOPMENT AUTHORITY PHILADELPHIA, PA

SHEET TITLE: **FLOOR PLANS, DEMO & FRAMING**
1734 S. 24th ST.

SCALE	AS NOTED
DRAWN BY	TS
APPROVED	MB
DATE	07/28/2014
DRAWING NO.	A1.1

A1.1

LIGHTING/POWER SYMBOLS:


▼ TELEPHONE/DATA	§ SWITCH	EP ELEC PANEL
TV CABLE	○ EXHAUST FAN	DB DOOR BELL
○ RECESSED FIXTURE	○ ELECTRIC OUTLET	2X4 SURFACE FLUORESCENT
○ WALL-MTD FIXTURE	○ SMOKE DETECTOR	UNDERCABINET LIGHT SIZE TO SUIT CONDITIONS
○ PENDANT FIXTURE	○ SMOKE DETECTOR AND CARBON MONOXIDE DETECTOR	
○ JUNCTION BOX	○ CEILING-MTD FIXTURE	
⊕ HOSE BIB	○ CEILING FAN w/ Light	

KEY NOTES

- 01 CLOSET ROD AND SHELF.
- 02 NEW CONCRETE PAVING WITH CONTROL JOINTS AS SHOWN.
- 03 NEW EXTERIOR STAIR AND LANDING WITH HANDRAIL SEE DET. E4/A.1
- 04 NEW GUTTER/SCUPPER, DOWNSPOUT, CAST IRON BOOT AND AREA DRAIN. PROVIDE NEW STORMWATER LINE AND CLEANOUT IN BASEMENT.
- 05 NEW 6'-0" WOOD SHADOWBOX TYPE FENCE AND 3'-0"W GATE W/ LOCKING HARDWARE.
- 06 NEW HOSE BIB.
- 07 NEW 4" CONCRETE SLAB; SLOPE TO SUMP PUMP. EXCAVATE TO ACHIEVE MIN. 7'-6" CLG HT IN BASEMENT. INSTALL NEW 4" PERF. DRAINAGE PIPE AROUND SLAB PERIMETER + CONNECT TO SUMP PUMP.
- 08 SEED + SOD PLANTING BED.
- 09 PROVIDE WASHER/DRYER HOOK-UPS BOX.
- 10 NEW EXTERIOR STAIR AND LANDING.
- 11 NEW BLOCK VENT.

DRAWING KEY

▨ NEW PARTITION
— NEW WORK
- - - EX'G. TO REMAIN
- - - EX'G. TO BE DEMOLISHED
— 2 HR FIRE RATED CONSTR.
□ SUPPLY GRILLE
□ RETURN GRILLE
□ SUPPLY DUCT
□ RETURN DUCT
↔ WALL RETURN

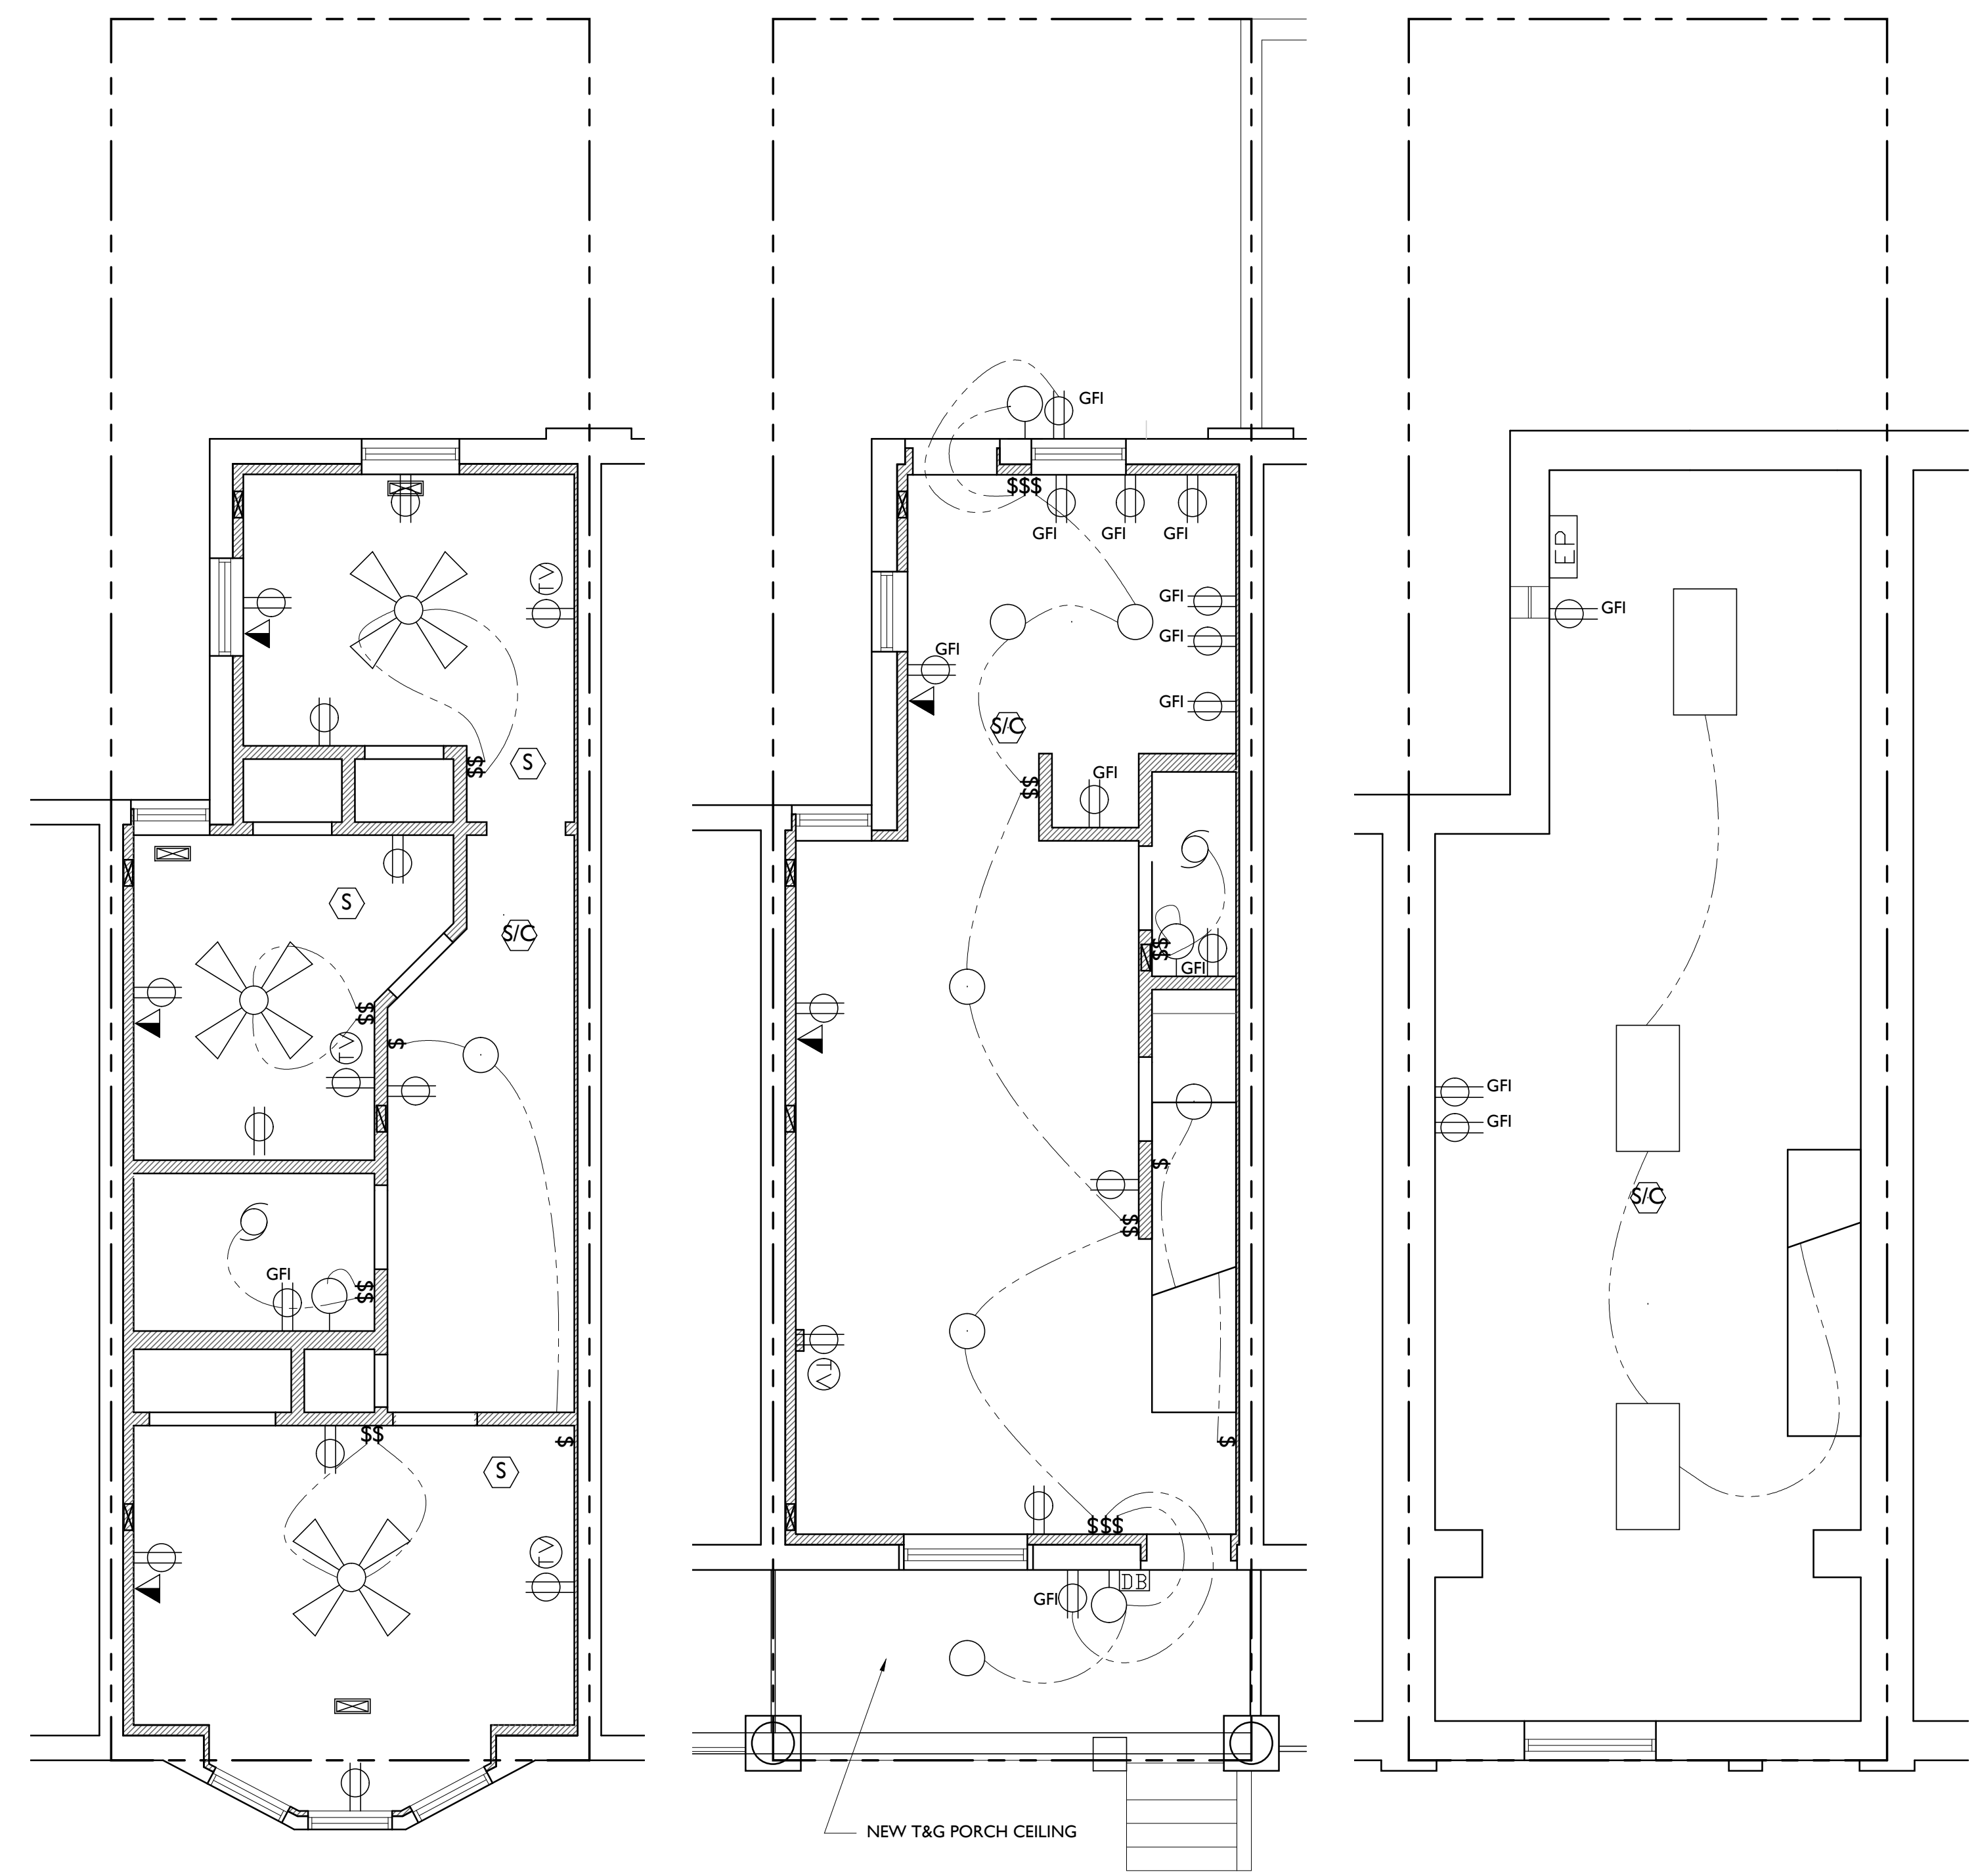


E4 REFLECTED CEILING PLANS
1/4" = 1'-0"

ALL DIMENSIONS AND EXISTING CONDITIONS SHALL BE THE CONTRACTOR'S RESPONSIBILITY TO VERIFY AT THE SITE. THE WORK SHALL COMPLY WITH APPLICABLE CODES AND REGULATIONS. JURISDICTION: PHILADELPHIA REDEVELOPMENT AUTHORITY. © 2014 CICADA ARCHITECTURE/PLANNING, INC.

REVISIONS:	DESCRIPTION:
No. DATE	

CONSULTANTS:

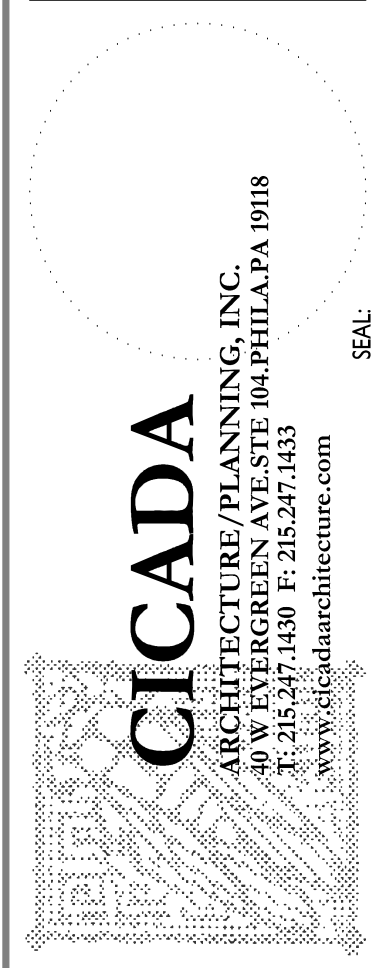


PROJECT:
POINT BREEZE SCATTERED SITE REHABS
PHILADELPHIA REDEVELOPMENT AUTHORITY
PHILADELPHIA, PA


SHEET TITLE:
REFLECTED CLG PLAN 1734 S. 24th ST.

SCALE:	AS NOTED
DRAWN BY:	TS
APPROVED:	MB
DATE:	07/28/2014
DRAWING NO.:	419.00


A1.2

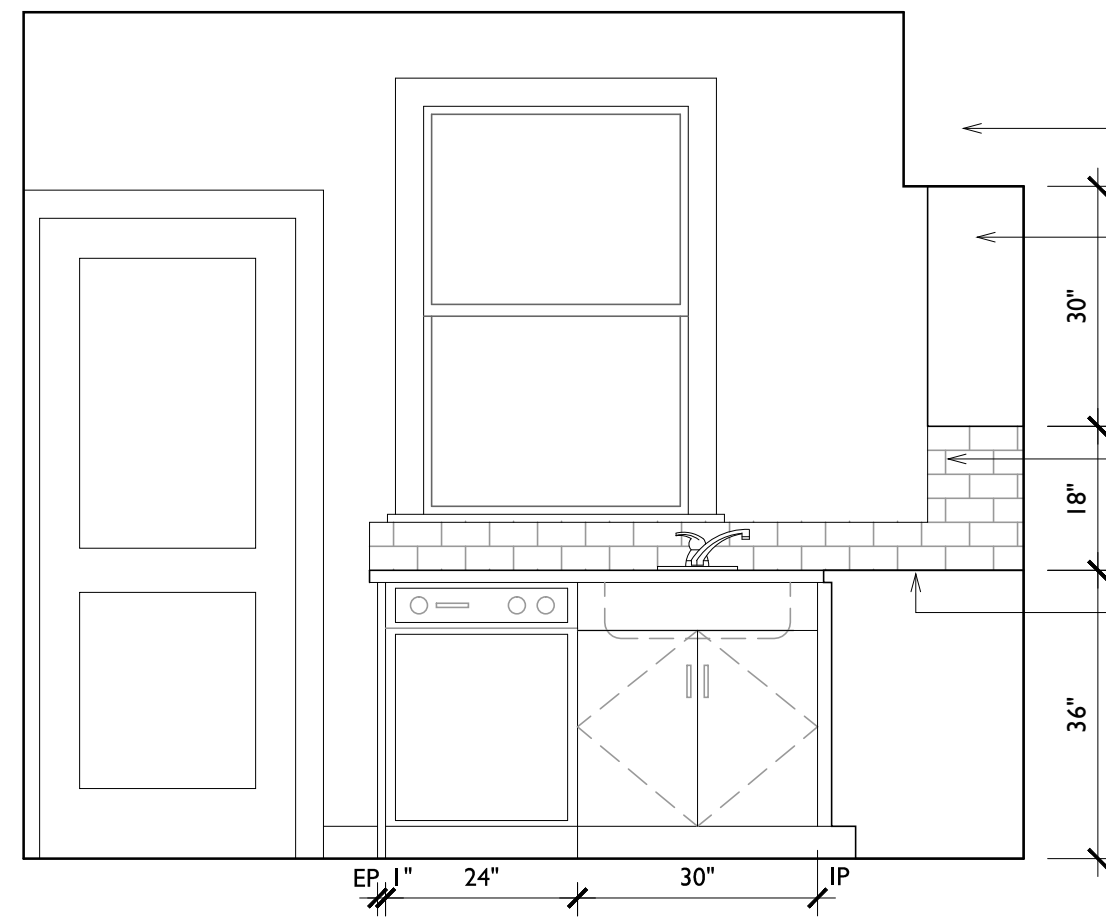


A1 KITCHEN ELEVATION
1/2" = 1'-0"

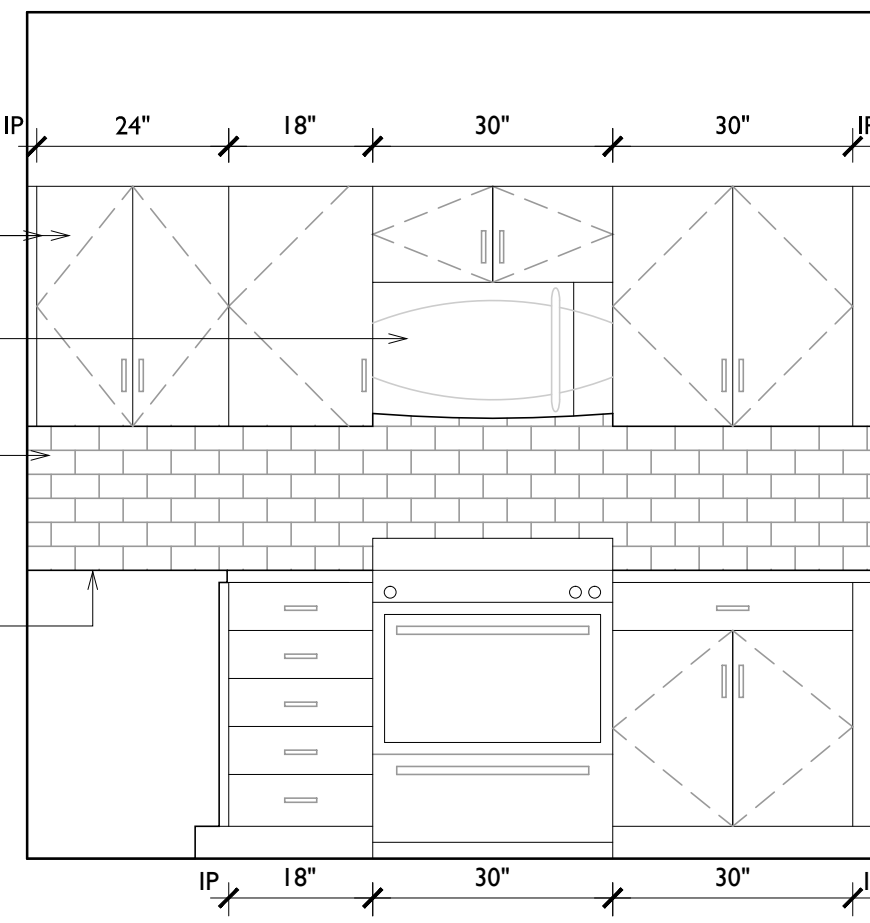


A3 KITCHEN ELEVATION
1/2" = 1'-0"

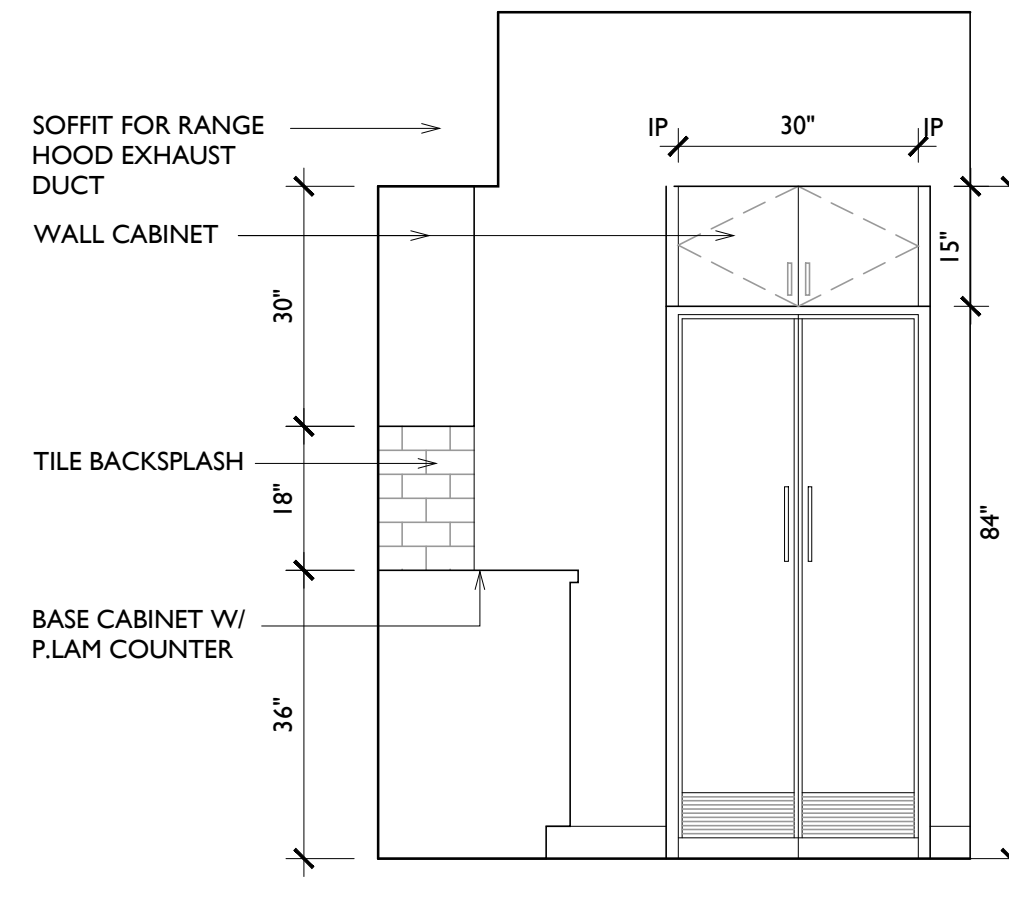


A4 KITCHEN ELEVATION
1/2" = 1'-0"

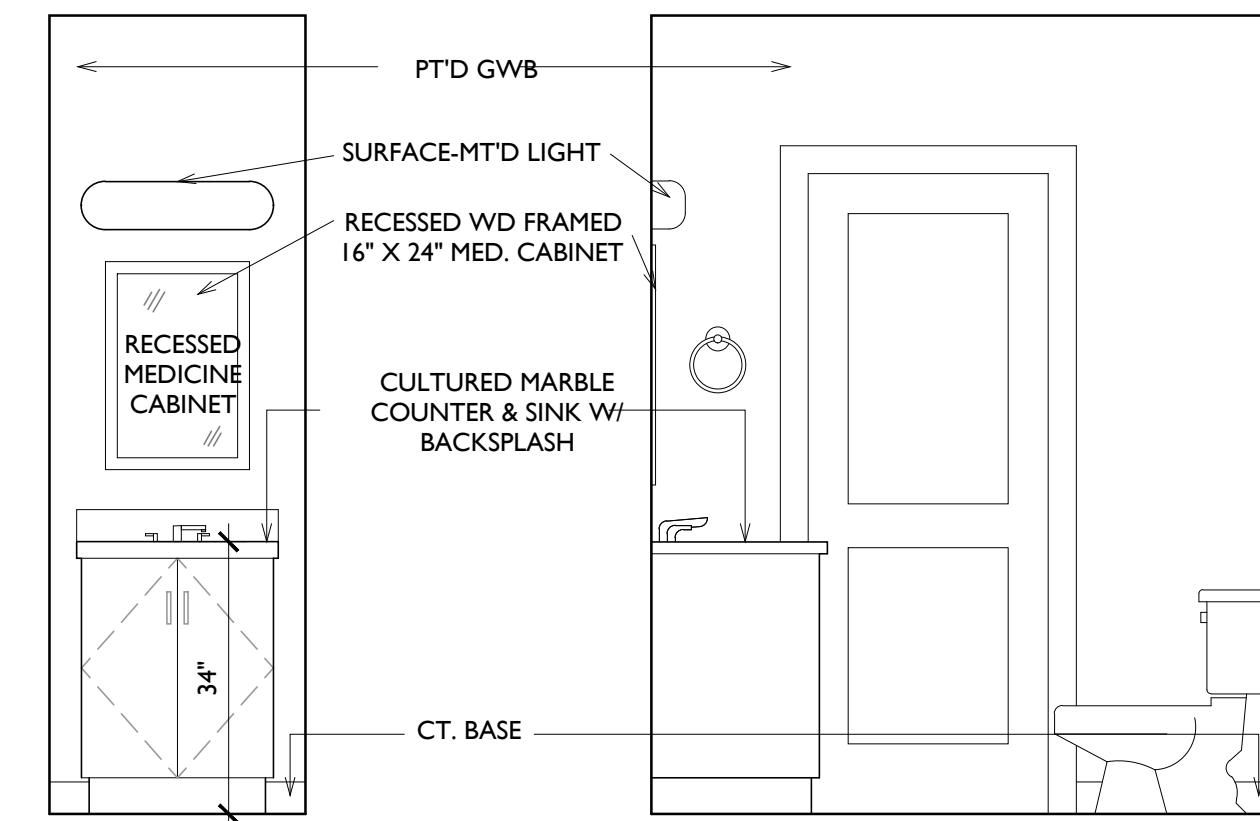


A5 POWDER ROOM ELEVATION
1/2" = 1'-0"

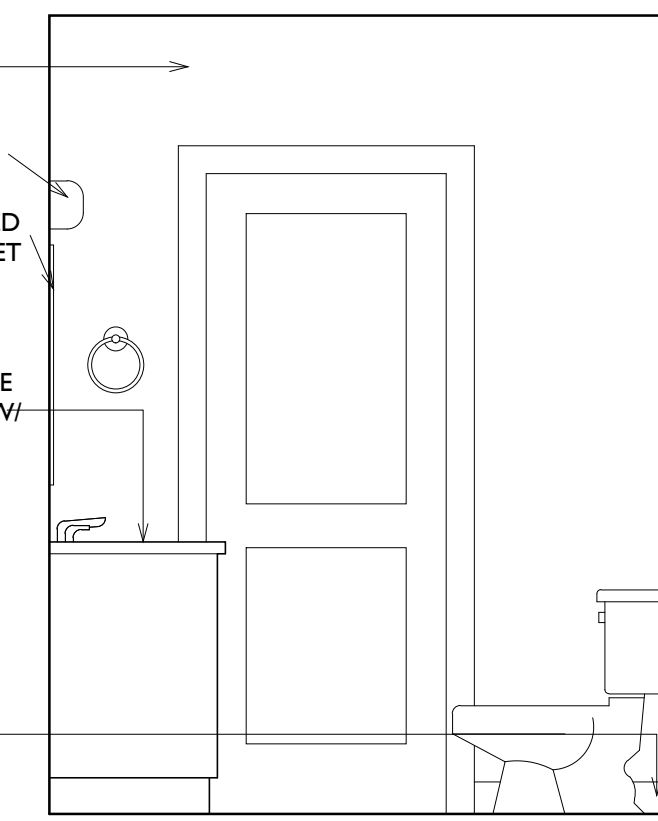


A6 POWDER ROOM ELEVATION
1/2" = 1'-0"

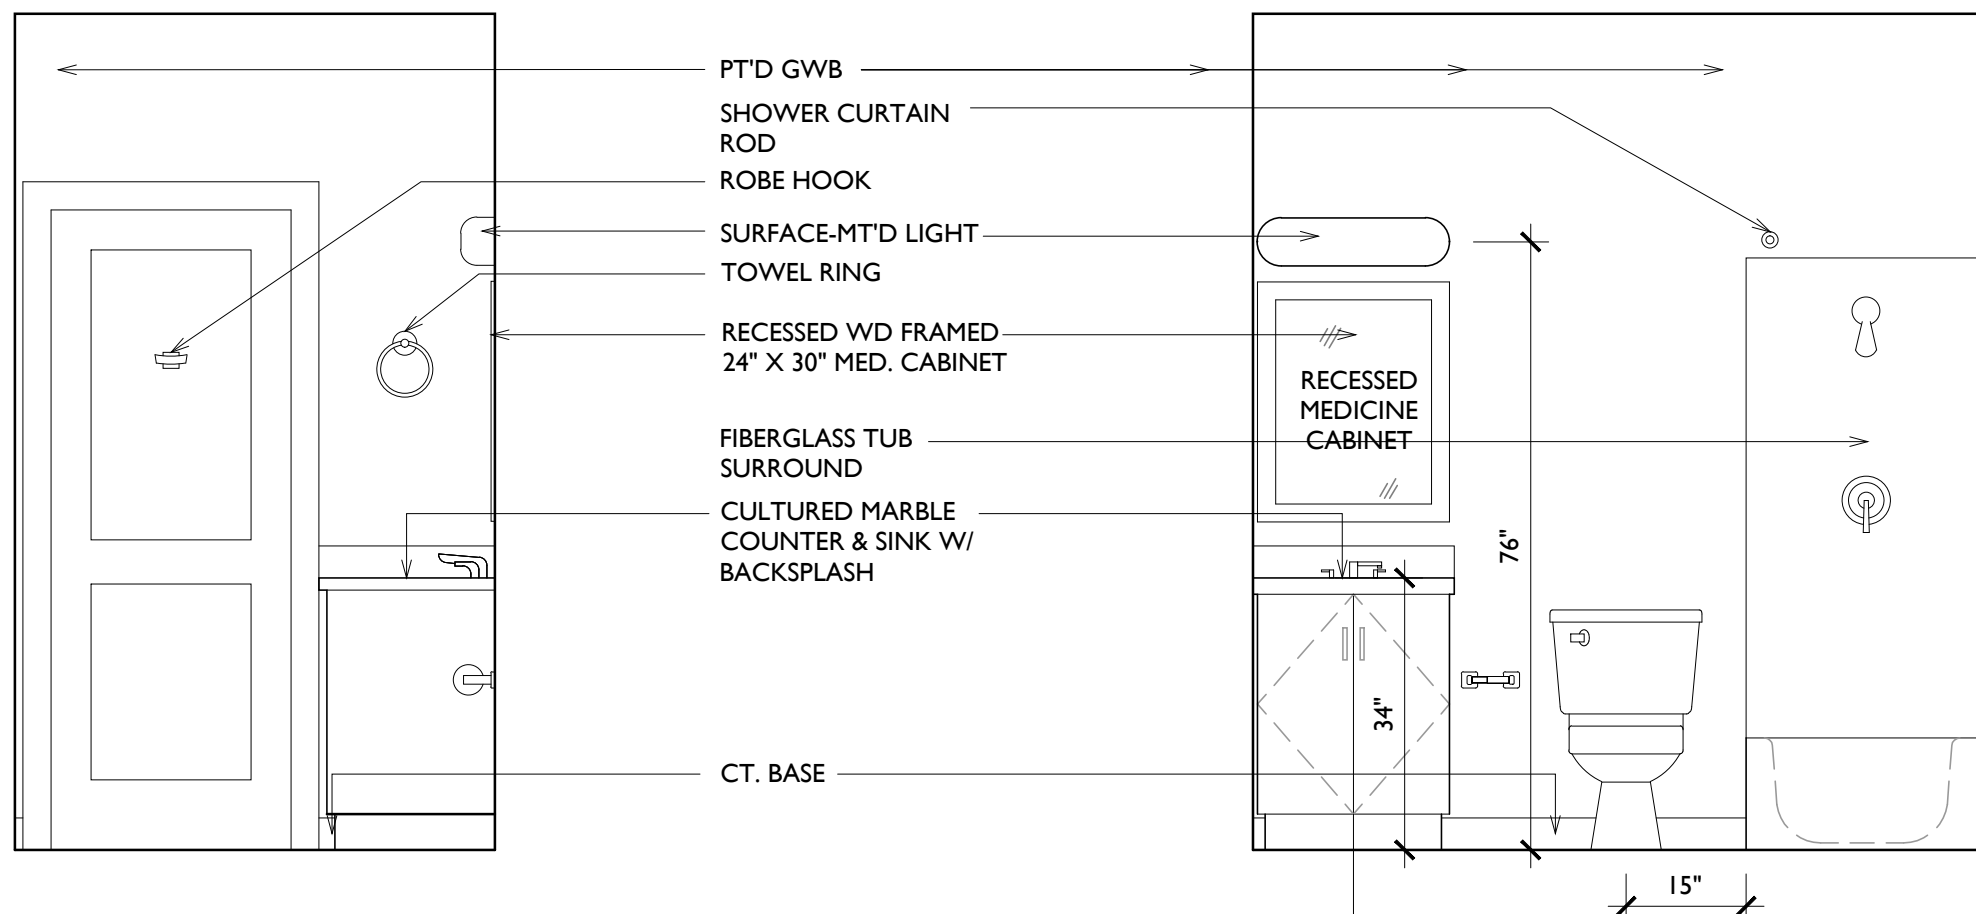


C1 BATH ELEVATION
1/2" = 1'-0"

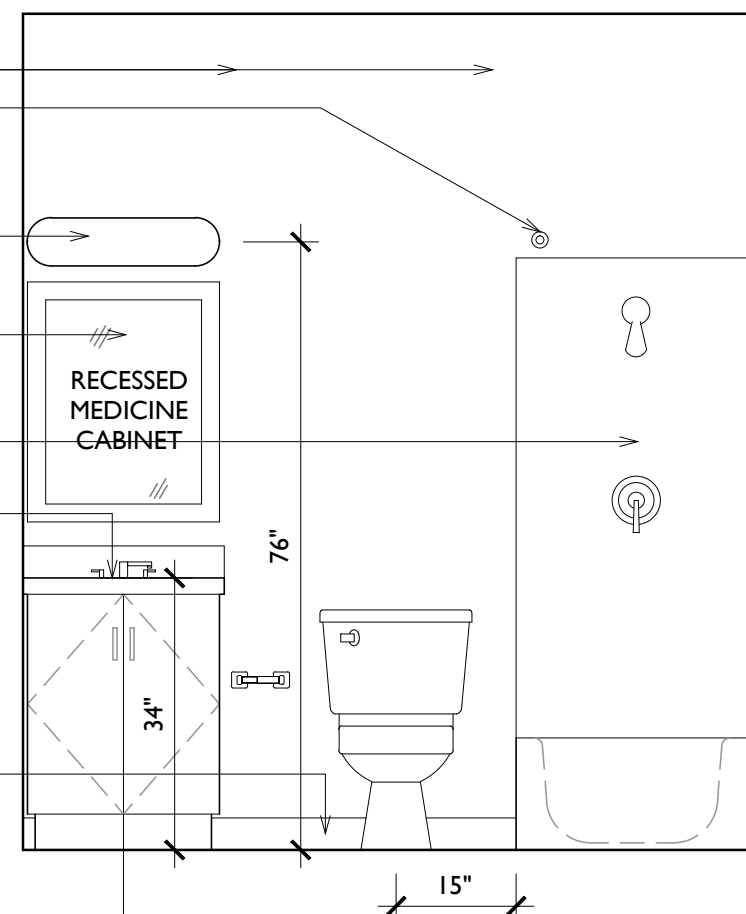


C2 BATH ELEVATION
1/2" = 1'-0"

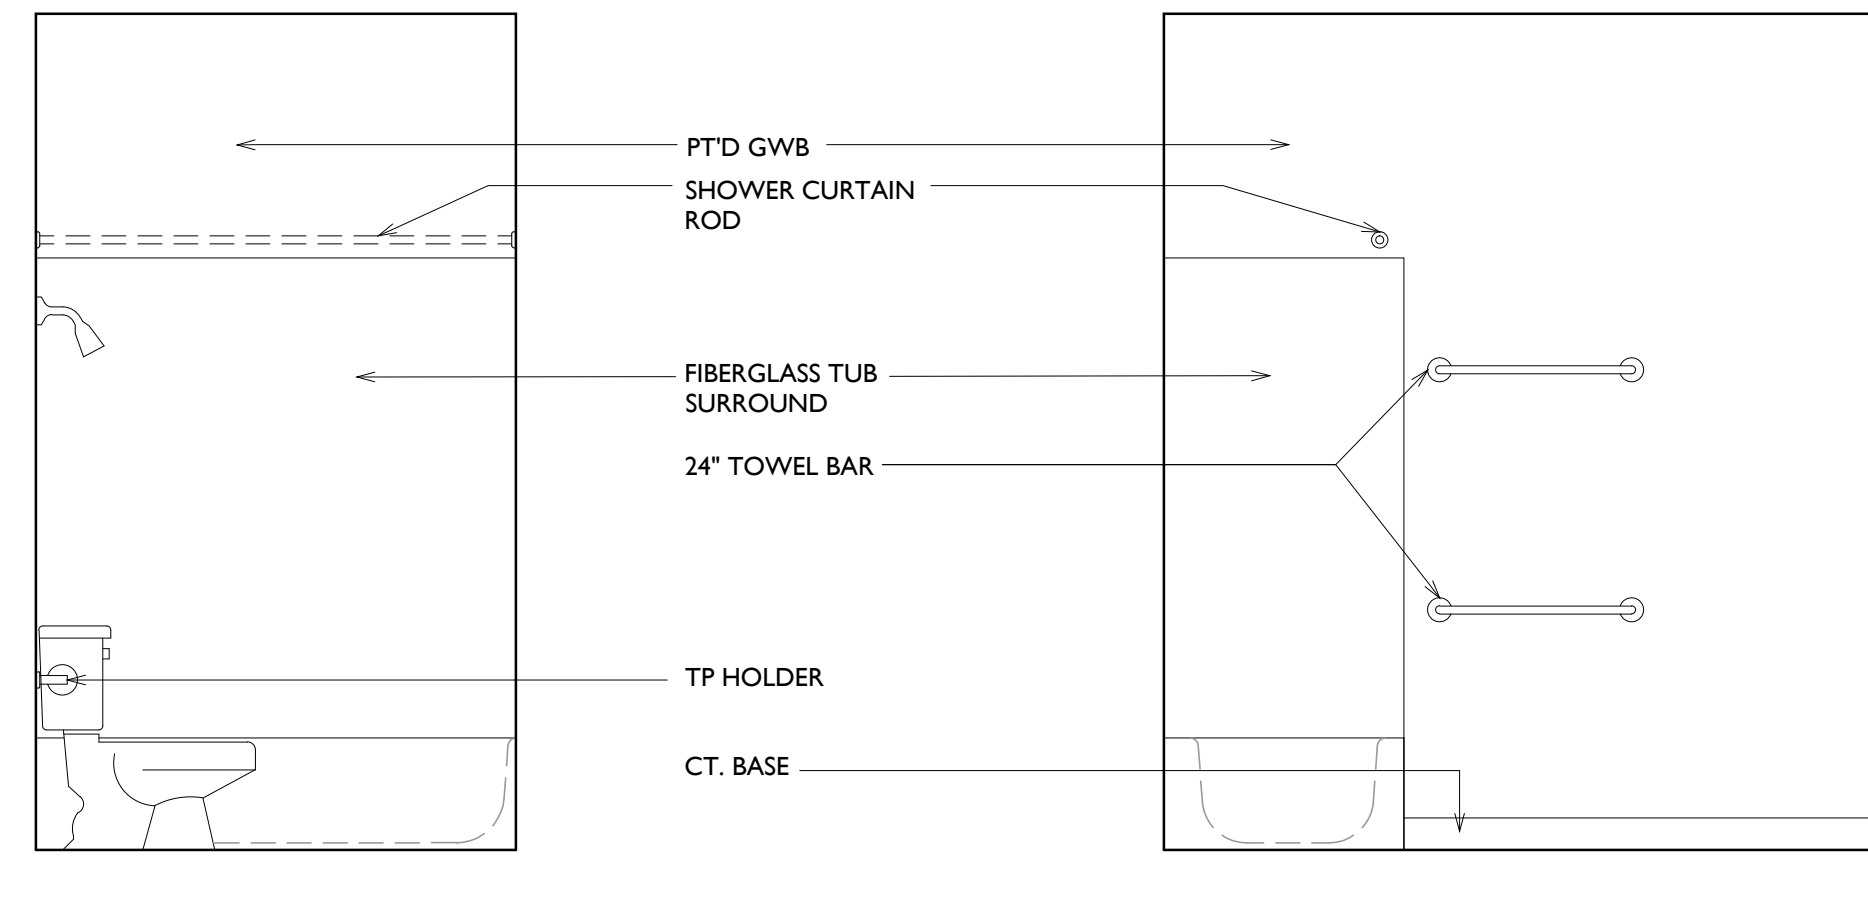


C3 BATH ELEVATION
1/2" = 1'-0"

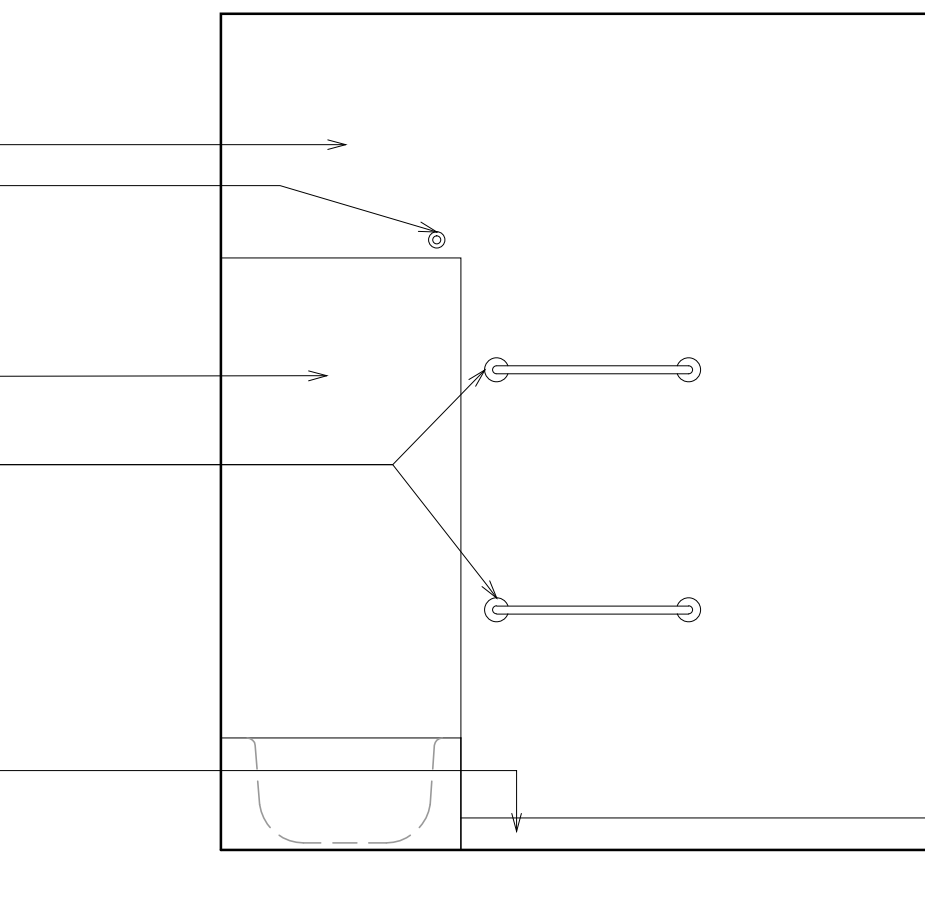


C4 BATH ELEVATION
1/2" = 1'-0"

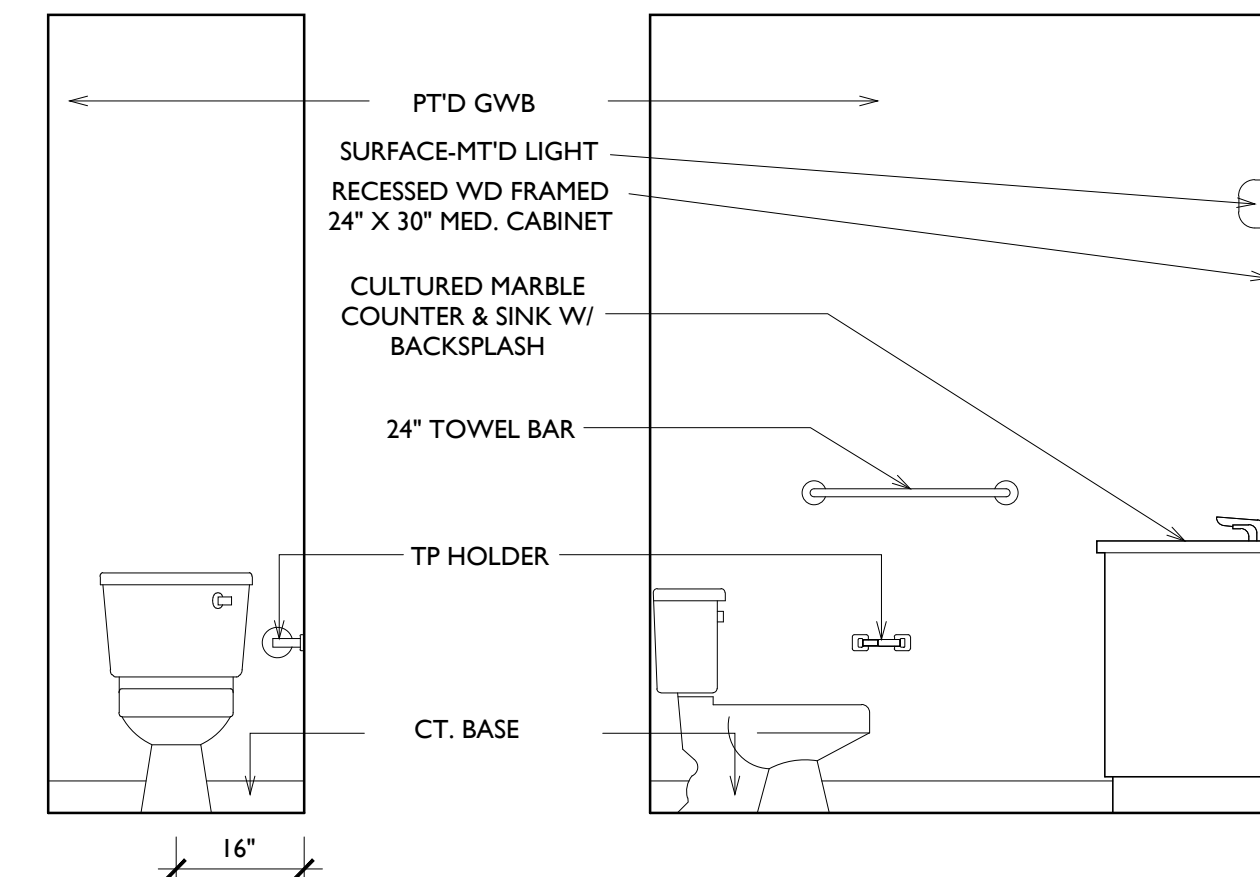


C5 POWDER ROOM ELEVATION
1/2" = 1'-0"

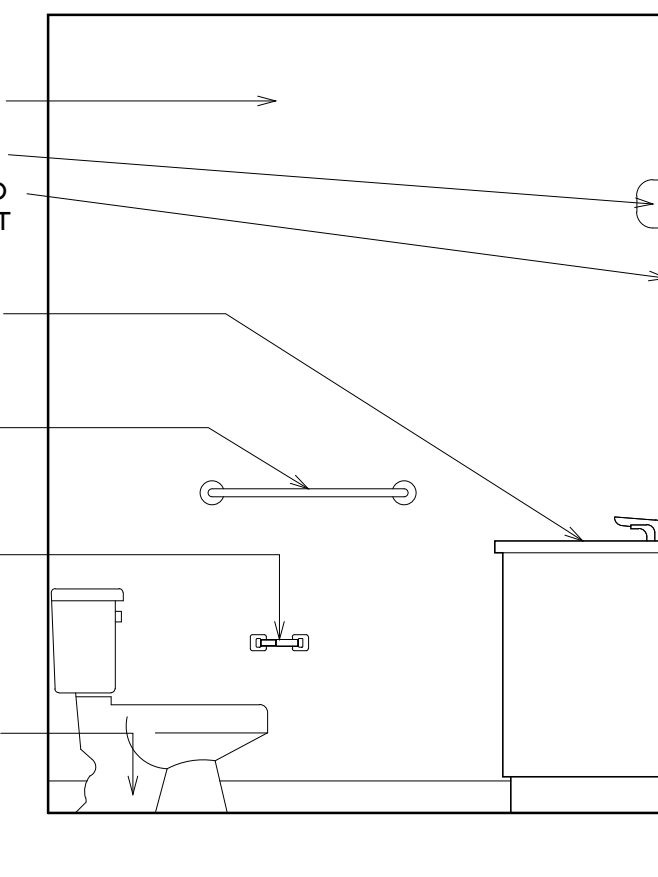


C6 POWDER ROOM ELEVATION
1/2" = 1'-0"

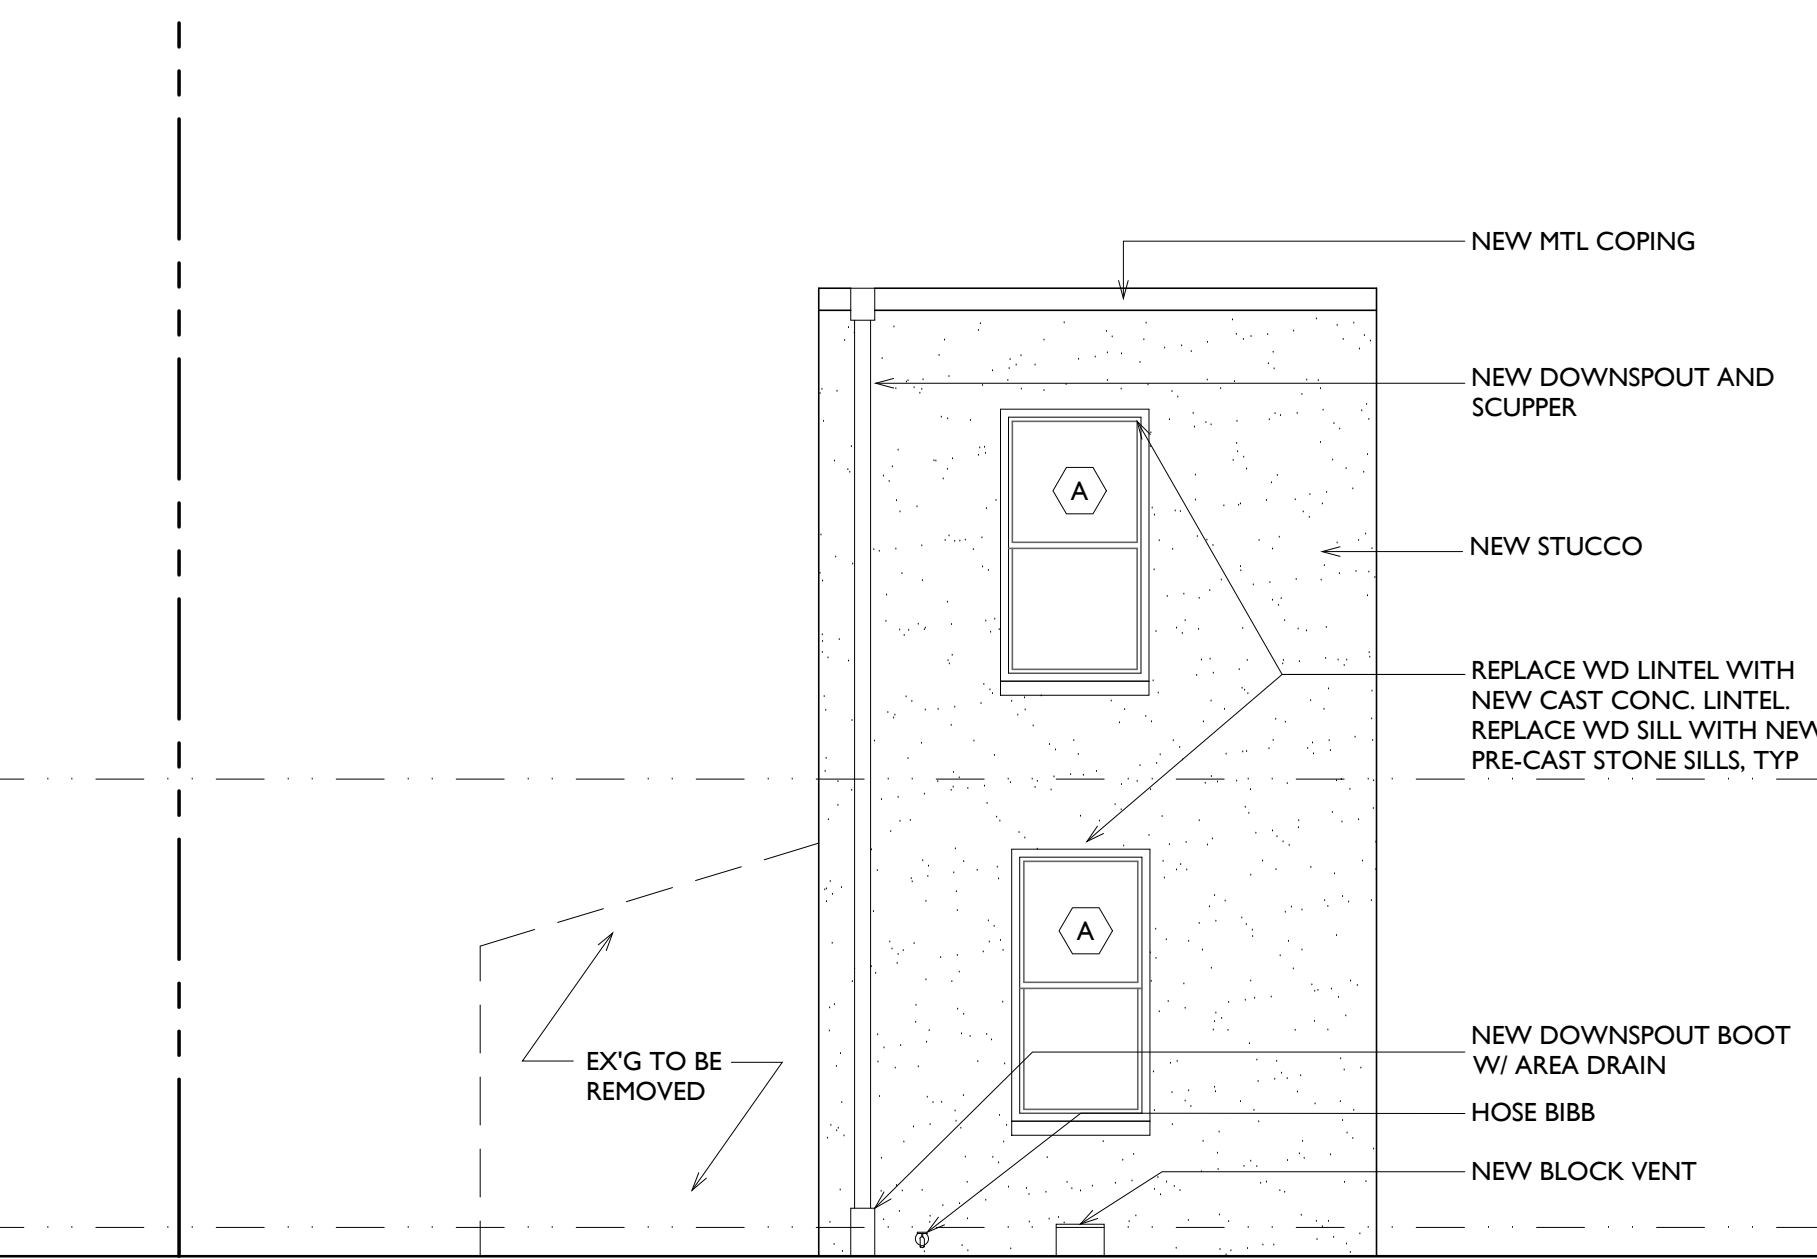

E1 SIDE ELEVATION
1/4" = 1'-0"

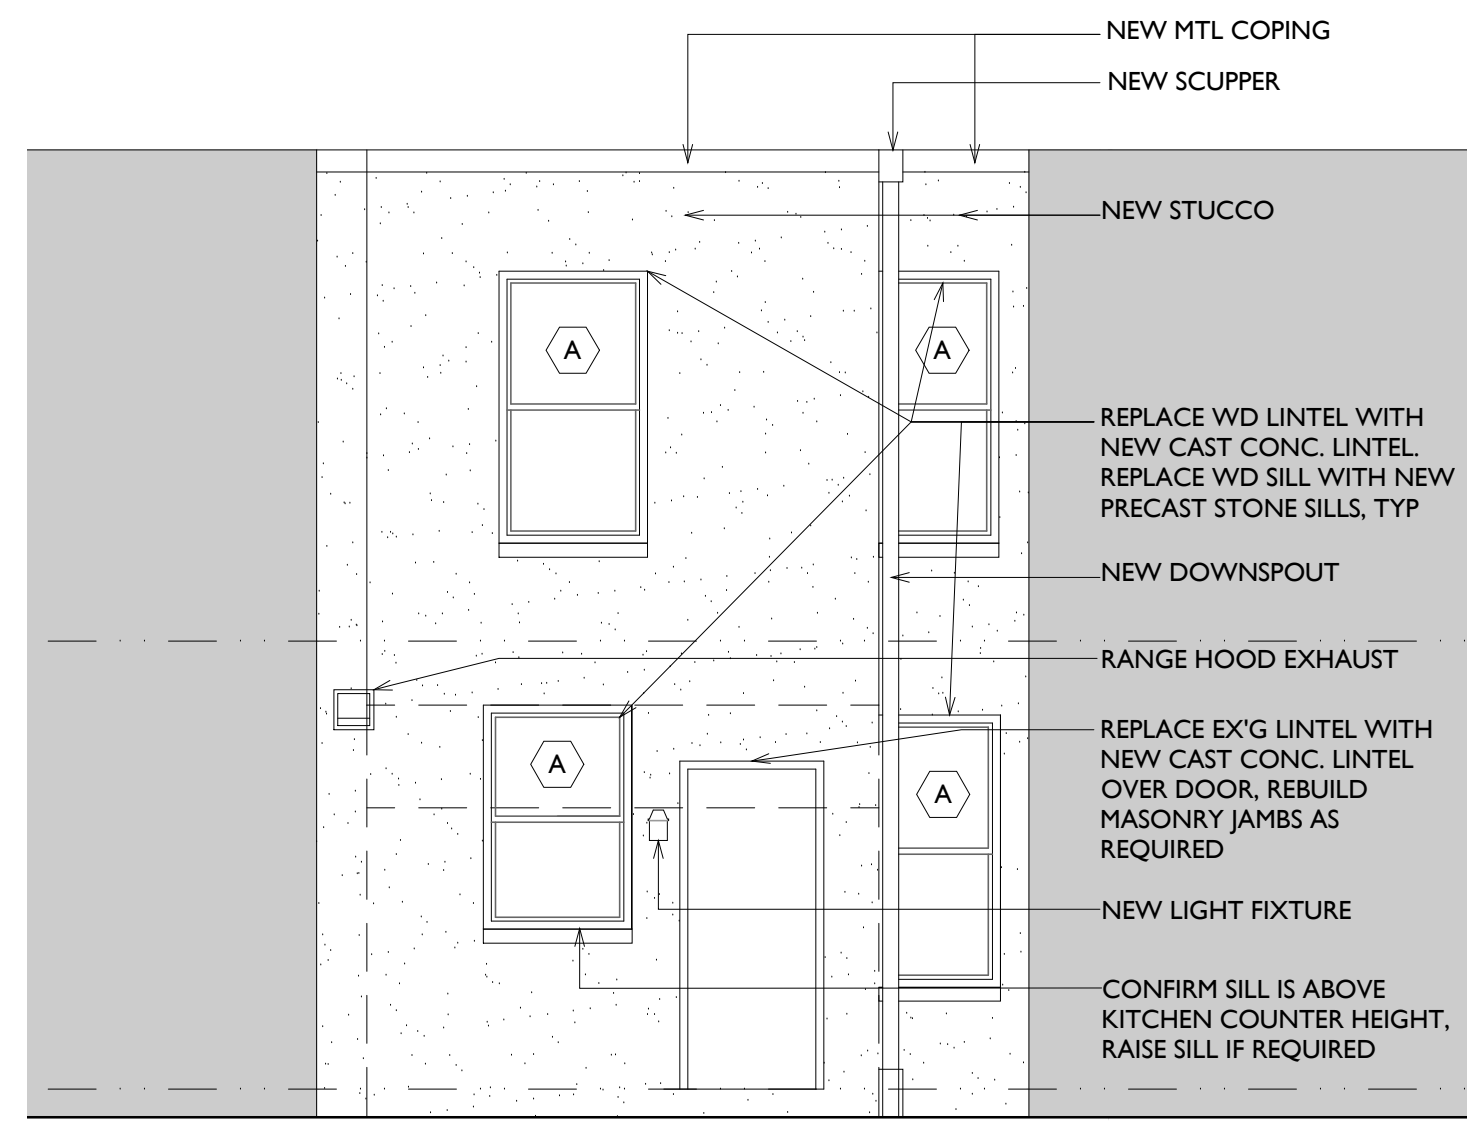

E3 REAR ELEVATION
1/4" = 1'-0"

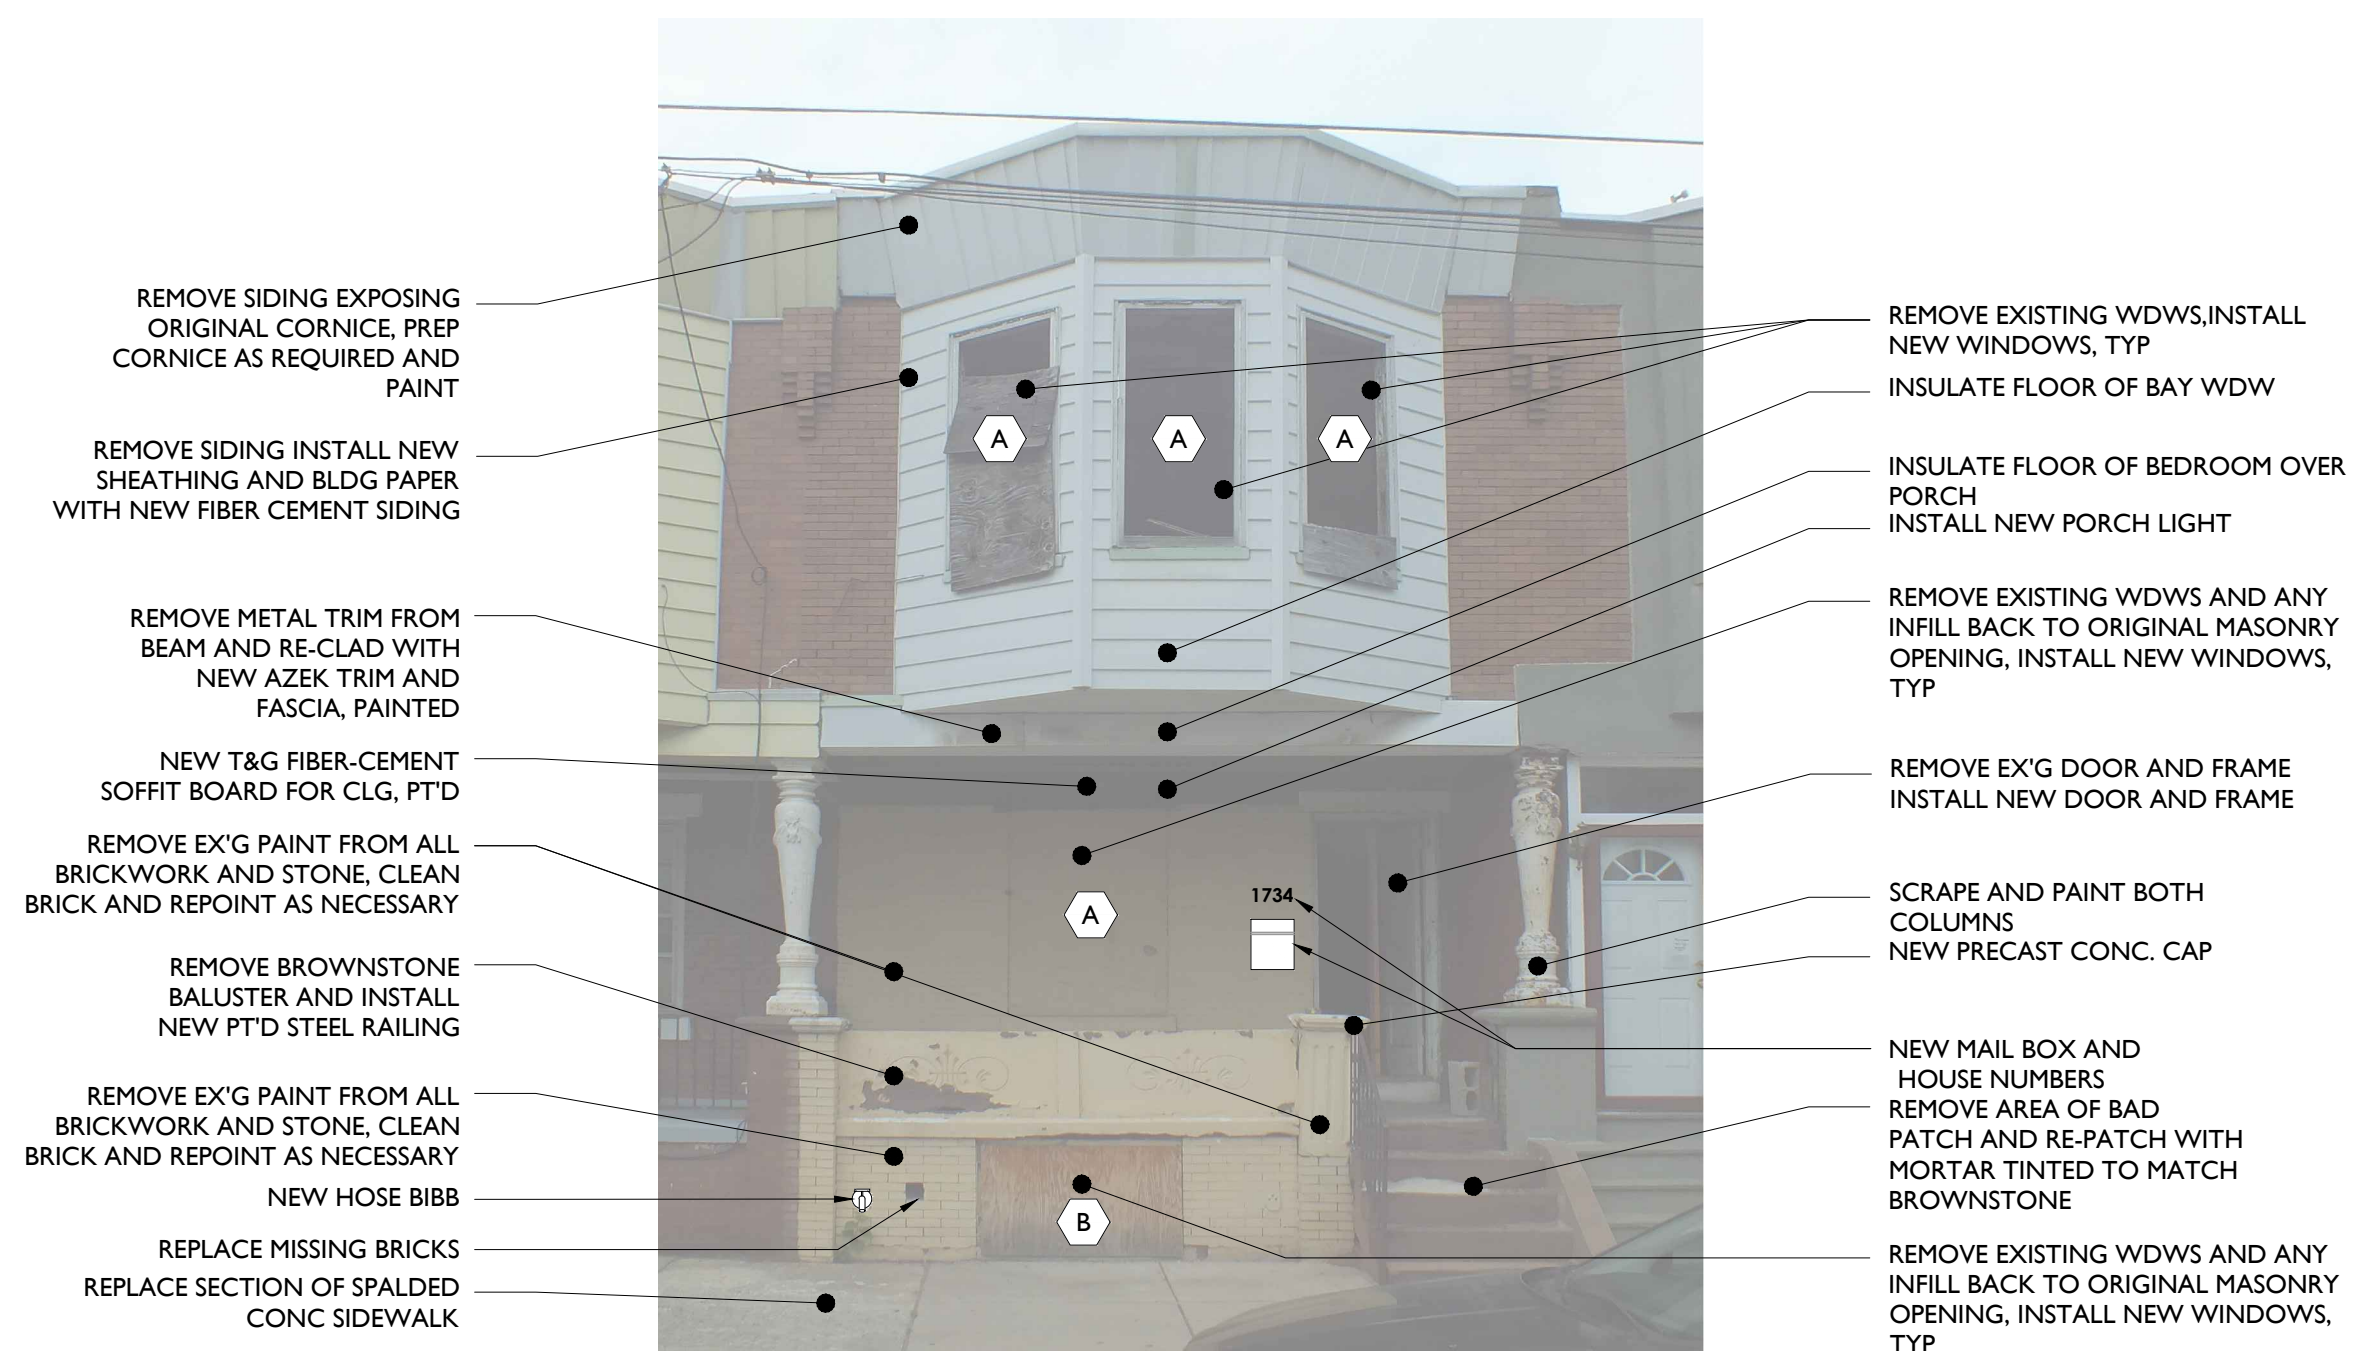


E5 FRONT ELEVATION
1/4" = 1'-0"

ALL DIMENSIONS AND EXISTING CONDITIONS SHALL BE VERIFIED BY THE CONTRACTOR AT THE SITE. THE WORK SHALL COMPLY WITH APPLICABLE CODES AND REGULATIONS HAVING JURISDICTION. © 2014 CICADA ARCHITECTURE/PLANNING, INC.

REVISIONS:	DESCRIPTION:
No. DATE	BY:

CONSULTANTS:

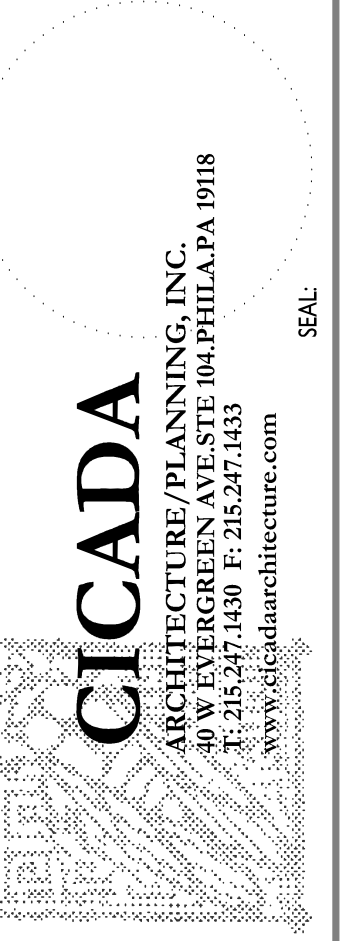

POINT BREEZE SCATTERED SITE REHABS
PHILADELPHIA REDEVELOPMENT AUTHORITY
PHILADELPHIA, PA

INTERIOR & EXTERIOR ELEVATIONS
1734 S. 24th ST.
PROJECT NO.: 419.00

SCALE:	AS NOTED
DRAWN BY:	TS
APPROVED:	MB
DATE:	07/28/2014
DRAWING NO.:	

A2.1